SOUTH LA PATERA LANE IMPROVEMENT PROJECT 27 SOUTH LA PATERA LANE, GOLETA, CA 93117

Invitation to Bid Set

Owner/Agency

CITY OF GOLETA Department of Neighborhood Services and Public Safety 130 Cremona Drive, Suite B Goleta, CA 93117 Contact: Jaime Valdez Ph: 805-961-7568

■ Landscape Architect ■ Electrical Engineer

ANIL VERMA ASSOCIATES, INC 444 South Flower Street, Suite #1688 Los Angeles, CA 90071 Contact: Jim Keenan / Warren Arata Ph: 213-624-6908

Geotech. Engineer

ENGEO Incorporated 2646 Santa Maria Way, Suite #107 Santa Maria, CA 93455 CONTACT: Randy Hildebrant, PE, GE Ph: 805-888-1110

Utility Coordination

WATER **GOLETA WATER DISTRICT** 4699 Hollister Ave Goleta, CA 93117 Contact: Dan Brooks Ph: 805-319-8481

NATURAL GAS SOUTHERN GAS COMPANY C/O Karl Monteleone Technical Services - Goleta 1171 More Ranch Road Goleta, CA 93111-2910 Ph: 805-681-7945

SEWER GOLETA SANITARY DISTRICT 1 WILLIAM MOFFETT PL Goleta, CA 93117 Contact: Luis Astorga Ph: 805-967-4519

Civil Engineer

MNS Engineers, Inc. 201 N. Calle Cesar Chavez, Suite 300 Santa Barbara, CA 93103 Contact: Shawn Kowalewski, PE Ph: (805) 456-3540

ANIL VERMA ASSOCIATES, INC 444 South Flower Street, Suite #1688 Los Angeles, CA 90071 Contact: Raymundo Cruz Ph: 213-624-6908

Survey Engineer

MNS, INC

201 N. Calle Cesar Chavez, Suite #300 Santa Barbara, CA 93103 Contact: Shawn Kowalewski, PE Ph: 805-692-6921

TELECOMMUNICATIONS

FRONTIER COMMUNICATIONS C/O Lad Kuzela **OSP Engineering** 22 S. Fairview Avenue Goleta, CA 93117 Ph: 805-964-8303

COX COMMUNICATIONS

22 S. Fairview Avenue Goleta, CA 93117 Contact: James Drenan Ph: 805-681-3844

ELECTRIC

SOUTHERN CALIFORNIA EDISON 301 David Love Place Goleta, CA 93117 Contact: Shawn Lee Ph: 805-535-5901

VICINITY MAP NOT TO SCALE






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SHAWN KOWALEWSKI Exp. 12/31/25

SHAWN KOWALEWSKI

03-04-24 DATE

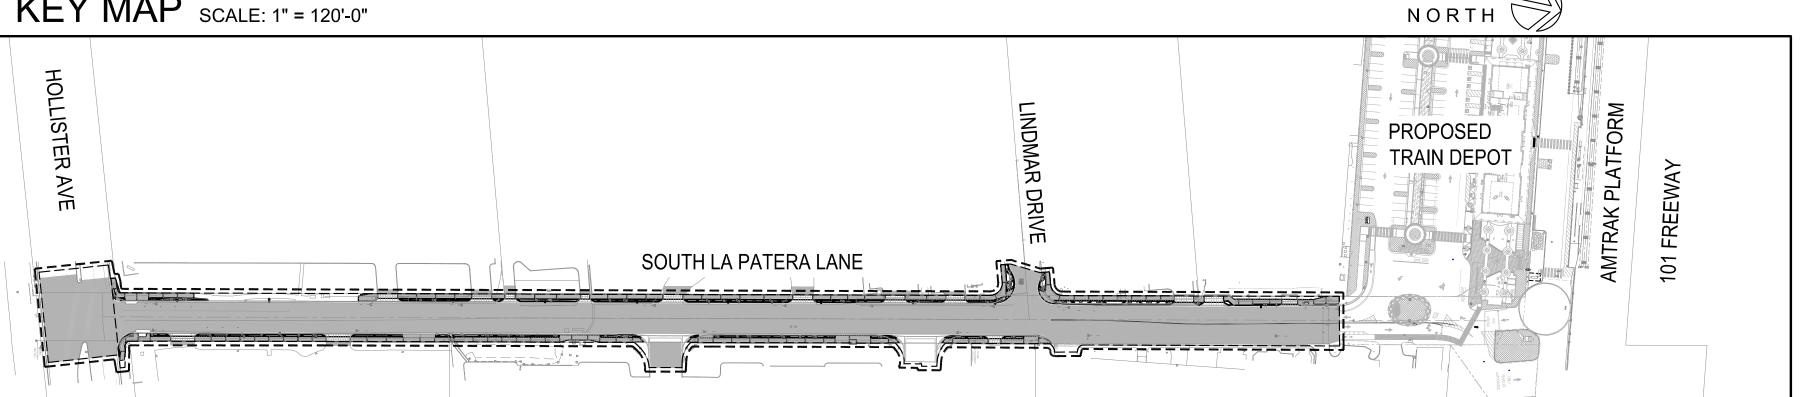

PATERA (FOR GC Cover She SOUTH CIP-9079

BID NO. SHT. DE G100 SHEET 1 OF 40

- 1. ALL WORK SHALL COMPLY WITH CODES, LAWS, & REGULATIONS OF PUBLIC AUTHORITIES GOVERNING THE WORK & CONFORMING TO 2022 EDITION TITLE 24, CALIFORNIA CODE OF REGULATIONS (CCR) WHERE THEIR REQUIREMENTS ARE MORE SPECIFIC OR STRINGENT.
- 2. CONTRACTOR SHALL OBTAIN & PAY FOR ALL PERMITS & ALL INSPECTIONS REQUIRED BY PUBLIC AUTHORITIES GOVERNING THE WORK
- 3. CONTRACTOR SHALL VERIFY ALL DIM. & CONDITIONS AT THE JOB SITE PRIOR TO START OF WORK. ARCHITECT SHALL BE NOTIFIED OF ANY DISCREPANCIES.
- 4. CONTRACTOR SHALL SUBMIT REQUESTS for SUBSTITUTIONS, REVISIONS, or CHANGES TO ARCHITECT PRIOR TO PURCHASE, FABRICATION or INSTALLATION
- 5. CONTRACTOR SHALL PROTECT AREA OF WORK AND ADJACENT AREAS ON SITE FROM BEING DAMAGED DURING CONSTRUCTION
- 6. COORDINATE WORK WITH THE OAR, INCLUDING SCHEDULING TIME & LOCATIONS FOR DELIVERIES, SITE ACCESS & USE OF SERVICES. MIN. DISTURBANCE TO NEIGHBORS
- 7. CONTRACTOR SHALL REMOVE AND DISPOSE OF ALL CONSTRUCTION DEBRIS OFF SITE
- 8. THE INFORMATION CONTAINED IN THESE CONSTRUCTION DOCUMENTS ARE TO BE FIELD VERIFIED PRIOR TO THE COMMENCEMENT OF CONSTRUCTION.
- 9. CONTRACTOR SHALL VERIFY AT SITE THE EXTENT OF WORK WHICH MAY OR MAY NOT BE INDICATED BY CLOUDS OR OTHERWISE ON THE DRAWINGS.
- 10. MAINTAIN WORK AREAS SECURE AND LOCKABLE DURING CONSTRUCTION
- 11. DO NOT SCALE DRAWINGS. WRITTEN DIMENSIONS SHALL GOVERN, IN CASE OF CONFLICT CONSULT OWNERS AUTHORIZED REPRESENTATIVE
- 12. AT THE COMPLETION OF CONSTRUCTION, REPAIR ALL DAMAGE TO THE PAVED AND LANDSCAPED AREAS DUE TO CONSTRUCTION ACTIVITY TO THE SATISFACTION OF IOR.
- 13. PROVIDE BARRICADES AND PROTECTION AS REQUIRED.
- 14. UNLESS SPECIFICALLY NOTED OTHERWISE IN THESE DRAWINGS, ALL EXISTING CONDITIONS SHALL REMAIN AS-IS
- ^{15.} ALL CONST. AS INDICATED BY (E) IS EXISTING, UNLESS NOTED AS (N), IS NEW.
- 16. DIMENSIONS ARE TO CENTER OF STRUCTURAL GRID OR FACE OF FINISH. UON.
- 17. CHANGES TO APPROVED DRAWINGS or SPEC'S SHALL BE MADE BY AN ADDENDA or CONSTRUCTION CHANGE DOCUMENT (CCD) APPROVED BY THE CITY, AS REQUIRED BY SECTION 4-338, PART 1, TITLE 24, CCR.

- 18. IF SHOWN IN SPECIFICATIONS BUT NOT THE DRAWINGS OR THE DRAWINGS BUT NOT THE SPECIFICATIONS, SCOPE WILL BE CONSIDERED PART OF BOTH.
- 19. IN CASE OF CONFLICT, THE MOST STRINGENT METHOD OF CONSTRUCTION SHALL GOVERN.
- 20. LOCATIONS OF UTILITIES INDICATED ON PLANS IS NOT GUARANTEED TO BE ACCURATE or COMPLETE. BUT IS PLOTTED for CONTRACTOR INFORMATION. IT SHALL BE THE CONTRACTOR'S RESPONSIBILITY TO DETERMINE EXACT LOCATIONS OF UTILITIES & SERVICE CONNECTIONS.
- 21. CONSTRUCTION DOCUMENTS ARE PROVIDED TO ILLUSTRATE DESIGN & GENERAL TYPE OF CONSTRUCTION DESIRED, & IMPLIES THE FINEST QUALITY OF CONSTRUCTION MATERIALS & WORKMANSHIP. CONTRACTOR IS ASSUMING RESPONSIBILITY FOR THE WORK INDICATED, & SHALL COMPLY WITH THE SPIRIT AS WELL AS THE LETTER IN WHICH THEY WERE DRAWN.
- 22 THE CONTRACTOR GUARANTEES THAT THE WORK PERFORMED WILL BE FREE FROM FAULTY MATERIALS & WORKMANSHIP. UPON RECEIPT OF NOTIFICATION FROM IOR, CONTRACTOR SHALL REMEDY, REPAIR or REPLACE IMMEDIATELY WITHOUT COST TO CITY ALL DEFECTS or IMPERFECTIONS APPEARING IN THE WORK. IT SHALL BE UNDERSTOOD. U.O.N. THAT ALL MATERIALS & WORKMANSHIP SHALL BE GUARANTEED FOR A PERIOD OF ONE YEAR BY CONTRACTOR FROM THE ACCEPTANCE OF THE PROJECT BY THE CITY OF GOLETA.
- 23. THE INTENT OF DRAWINGS & SPECIFICATIONS IS THAT THE WORK OF THE CONSTRUCTION IS TO BE IN ACCORDANCE WITH TITLE 24. CCR. SHOULD ANY EXISTING CONDITIONS SUCH AS DETERIORATION OR NON-COMPLYING CONSTRUCTION BE DISCOVERED WHICH IS NOT COVERED BY THE CONTRACT DOCUMENTS WHEREIN THE FINISHED WORK WILL NOT COMPLY WITH TITLE 24, CCR, A CONSTRUCTION CHANGE DOCUMENT (CCD), OR A SEPARATE SET OF PLANS AND SPECIFICATIONS, DETAILING & SPECIFYING THE REQUIRED WORK SHALL BE SUBMITTED TO AND APPROVED BY CITY BEFORE PROCEEDING WITH THE WORK. (SECTION 4-317 (C), CBSAC, PART 1, TITLE 24, CCR)
- 24. CITY OAR SHALL NOTIFY ARCHITECT OR ENGINEER OF RECORD (AOR/EOR), PRIOR TO CONSTRUCTION START DATE, FOR CONSTRUCTION OBSERVATION AND SUPPORT SERVICES.
- 25. EXISTING DRAWINGS & SITE VISITATION: CONTRACTOR SHALL VISIT THE SITE, EXAMINE THE EXISTING CONDITIONS OF THE NEW CONSTRUCTION & DETERMINE TO THEIR SATISFACTION THE METHODS & PROCEDURE, REMOVAL & STORAGE OF MATERIALS, SEQUENCING OF OPERATIONS AND CONDITIONS WHICH AFFECT ITS WORK & PROBLEMS ATTENDANT HERETO. NO ALLOWANCE WILL BE MADE SUBSEQUENTLY TO THE CONTRACTOR FOR ATTENDANT HERETO AND/OR FOR ERRORS THROUGH NEGLIGENCE IN EXAMINING SITE CONDITIONS
- 26. COORDINATE HARDSCAPE WORK W/ ALL DISCIPLINES FOR SLEEVING, CONDUITS, ANCHOR BOLTS, ETC.

- 27. DIMENSIONS ARE FROM OUTSIDE FACE OF PAVING, WALLS, ETC., UNLESS OTHERWISE INDICATED
- 28. ALL JUNCTION & VALVE BOXES SHALL BE IN PLANTING AREAS AS APPROVED BY OWNER. STAKE LOCATIONS BEFORE INSTALLATION FOR APPROVAL BY OWNER





PUBLIC WORKS DEPARTMENT ENGINEERING DIVISION

PATERA (FOR GO Genera

CIP-9079

3/4/2024

9-30-25 RENEWAL DATE

BID NO. SHT. DE G101 SHEET 2 OF 40

ABBREVIATIONS

DETAIL

DIAMETER

DOWN DOWNSPOUT ASPHALTIC CONCRETE ACCESSIBLE **ADJUSTABLE** DRAWING ABOVE FINISH FLOOR END CURVE ELECTRICAL CONTROL PANEL **ALTERNATE** ALUMINUM END CURB RETURN
ELECTRICAL METER
EDGE OF PAVING
EQUAL ASSESSOR PARCEL NUMBER AMERICAN PUBLIC WORKS ASSOC. ASPHALT AUTOMATIC ELECTRICAL BOTTOM BLOW OFF ET CETERA ELECTRICAL BEGIN CURVE **EXPANSION JOINT** BEGIN CURVE RETURN **EXTERIOR** BACK FLOW VALVE **EXISTING** BUILDING **EXISTING** BEGIN VERTICAL CURVE ELEVATION BEGIN VERTICAL CURVE STATION END VERTICAL CURVE ELEVATION END VERTICAL CURVE STATION CALIFORNIA FRONTIER COMMUNICATIONS CENTER LINE FINISH FINISH FLOOR FIRE HYDRANT FIN FF CATCH BASIN CHAIN LINK FENCE CLEAR CONC. MASONRY UNIT FH FIN **FINISH** CURB OUTLET DRAIN FLR FLOOR FOM FACE OF MASONRY FT (') FOOT, FEET COMMUNICATIONS CONCRETE CONSTRUCTION CONT CONTINUOUS COORD COORDINATION / COORDINATE GAUGE GALVANIZED GRADE BREAK CROSSWALK GAS METER GROUND SURFACE DOUBLE GOLETA TRAIN DEPOT DEMOLITION GEN'L GENERAL DIMENSION

GAS VALVE

GOLETA WATER DISTRICT

HOUR HOME OWNER ASSOCIATION HÖT MIX ASPHALT INSIDE DIAMETER IRRIGATION CONTROL VALVE INTERSECTION LAYOUT LINE LOCATION POUND MATERIAL **MAXIMUM** MECHANICAL MANUFACTURER MINIMUM **MISCELLANEOUS** METAL MAILBOX NOT IN CONTRACT NUMBER or POUND NOT TO SCALE ON CENTER OUTSIDE DIAMETER O.F.C.I. OWNER FURNISHED CONTRACTOR INSTALLED O.F.& I. OWNER FURNISHED & **INSTALLED** ORIGINAL GROUND OPPOSITE OPPOSITE HAND

PROPERTY LINE PLANTING AREA PA PKWY PARKWAY PLASTER PLAS PLYWOOD PLASTIC LAMINATE POWER POLE POINT OF VERTICAL INTERSECTION
POINT OF VERTICAL INTERSECTION ELEVATION
POINT OF VERTICAL INTERSECTION STATION R, RAD RADIUS REFERENCE ROAD RELOCATE REMOVE REINFORCEMENT RET Rplc R RM RETURN RESTROOM RIGHT REQUIRED REVISED STANDARD PLAN RIGHT OF WAY SQUARE FEET SIMILAR SPECIFICATION STAINLESS STEEL STEEL SOUTHERN CALIFORNIA EDISON STANDARD STRUCT. STRUCTURAL SUSPENDED SW SC **SWITCH**

SAWCUT

TOP OF SLAB TRAFFIC SIGNAL BOX
TRAFFIC SIGNAL POLE
TRAFFIC SIGNAL PULL BOX TOP OF WALL TRESH. THRESHOLD TYP. TYPICAL UNLESS (OTHERWISE) NOTED OTHERWISE UTILITY POLE VARIABLE VERTICAL VERIFY IN FIELD WHERE OCCURS

SCG SOUTHERN CALIFORNIA GAS COMPANY
SL STREET LIGHT
SPPWC STANDARD PLANS FOR PUBLIC WORKS

SANITARY SEWER STATE STANDARD PLAN

STATE ROUTE

SIDEWALK

SYCAMORE

TOP OF CURB

TOP OF FOUNDATION

CONSTRUCTION (GREENBOOK BY APWA)

TEMPORARY CONSTRUCTION EASEMENT

WATER PROOF WEAKENED-PLANE JOINT WEIGHT WELDED WIRE FABRIC

KOWALEWSKI

No. 59539

Exp. 12/31/25

PROJECT ENGINEER:

03-04-24 SHAWN KOWALEWSKI

GENERAL NOTES

- 1. ALL WORK MUST BE PERFORMED IN ACCORDANCE WITH THE STATE OF CALIFORNIA DEPARTMENT OF TRANSPORTATION (CALTRANS) 2022 STANDARD PLANS, OR WHEN NOT COVERED BY CALTRANS STANDARDS, INCLUDE CITY OF GOLETA STANDARD DETAILS, STANDARD PLANS FOR PUBLIC WORKS CONSTRUCTION (SPPWC) LATEST EDITION AND SUPPLEMENTS, WITH THE MOST STRINGENT GOVERNING.
- 2. LOCATION OF UTILITIES HAVE BEEN SHOWN TO THE BEST OF THE ENGINEER'S ABILITY AND FROM DATA AND RECORDS FURNISHED BY THE REPRESENTATIVES OF THE VARIOUS UTILITY OWNERS. IT IS THE RESPONSIBILITY OF THE CONTRACTOR TO DETERMINE THE TRUE LOCATION AND IDENTIFY OF ANY/ALL UNDERGROUND UTILITIES AND VERIFY ALL CONDITIONS ON THE JOB SITE. CONTRACTOR MUST POTHOLE TO VERIFY THE LOCATION OF EACH AND COORDINATE WITH RESPECTIVE OWNERS FOR RELOCATION, IF NECESSARY. HAND DIG EXCAVATIONS UNTIL CLEAR OF OBSTRUCTIONS.
- 3. CONTRACTOR WILL MAKE EXPLORATION EXCAVATIONS AND LOCATE EXISTING UNDERGROUND FACILITIES SUFFICIENTLY AHEAD OF CONSTRUCTION PERMIT REVISIONS TO PLANS IF REVISIONS ARE NECESSARY BECAUSE OF ACTUAL LOCATION OF EXISTING FACILITIES.
- 4. CONTRACTOR IS RESPONSIBLE FOR DAMAGE TO ANY PUBLIC OR PRIVATE UTILITIES AND/OR STRUCTURES SHOWN OR NOT SHOWN ON THESE PLANS. CONTRACTOR IS REQUIRED TO TAKE DUE PRECAUTIONARY MEASURES TO PROTECT THE UTILITIES OR STRUCTURES FOUND AT THE SITE. IT IS THE CONTRACTOR'S RESPONSIBILITY TO NOTIFY THE UTILITY OWNERS BEFORE STARTING WORK (TWO WORKING DAYS NOTICE REQUIRED).
- 5. CONTRACTOR MUST COMPLY WITH ALL APPLICABLE DIVISION OF INDUSTRIAL RELATIONS (CAL/OSHA OR DOSH) SAFETY STANDARDS, IN ACCORDANCE WITH SECTION 7-10.4 OF THE SSPWC. CONTRACTOR MUST PROVIDE PROOF OF A PERMIT FROM CAL/OSHA IF REQUESTED BY THE INSPECTOR.
- 6. CONTRACTOR MUST NOTIFY UNDERGROUND SERVICE ALERT (USA) AT 1(800) 422-4133 AT LEAST TWO (2) WORKING DAYS PRIOR TO THE COMMENCEMENT OF CONSTRUCTION TO ALLOW UTILITY OWNERS TO MARK THE LOCATION OF THEIR RESPECTIVE UNDERGROUND FACILITIES/UTILITIES, PUBLIC OR PRIVATE, SHOWN OR NOT SHOWN ON THESE PLANS.
- 7. THE ENGINEER PREPARING THESE PLANS IS NOT RESPONSIBLE FOR, OR LIABLE FOR, UNAUTHORIZED CHANGES TO OR USES OF THESE PLANS. ALL CHANGES TO THE PLANS MUST BE APPROVED BY THE ENGINEER.
- 8. ACRONYMS AND ABBREVIATIONS ARE PER STANDARD SPECIFICATION AND PLANS AND SUPPLEMENTED BY CALTRANS STANDARD PLANS A3A, A3B, A3C, AND THIS SHEET.
- 9. WORK IN PUBLIC STREETS MUST BE PROSECUTED TO COMPLETION WITHOUT DELAY SO AS TO PROVIDE MINIMUM INCONVENIENCE TO ADJACENT PROPERTY OWNERS AND TO THE TRAVELING PUBLIC.
- 10. CONTRACTOR MUST PROTECT ADJACENT PROPERTIES FROM ALL DAMAGE THAT MAY OCCUR FROM STORM WATER RUNOFF AND/OR DEPOSITION OF DEBRIS RESULTING FROM ANY AND ALL WORK IN CONNECTION WITH CONSTRUCTION.
- 11. CONTRACTOR MUST PROVIDE AND MAINTAIN ACCESS TO ALL PROPERTIES FOR THE DURATION OF THE PROJECT. IF ACCESS IS LIMITED DUE TO CONSTRUCTION ACTIVITIES, THE CONTRACTOR MUST PROVIDE ACCESS WITHIN 15 MINUTES. DRIVEWAYS MAY BE CLOSED TO VEHICLE ACCESS FOR UP TO 3 DAYS.
- 12. CONTRACTOR MUST FIELD VERIFY ALL CONTROLLING DIMENSIONS PRIOR TO ORDERING MATERIALS AND COMMENCING WORK.
- 13. THE CONTRACTOR MUST DESIGN, CONSTRUCT, AND MAINTAIN ALL SAFETY DEVICES, INCLUDING SHORING, AND IS SOLELY RESPONSIBLE FOR CONFORMING TO ALL LOCAL, STATE, AND FEDERAL SAFETY AND HEALTH STANDARDS, LAWS, AND REGULATIONS.
- 14. ALL TRENCH REPAIR, BACKFILL, AND COMPACTION MUST BE INSPECTED BY THE PUBLIC WORKS DEPARTMENT.
- 15. CONTRACTOR MUST KEEP THE WORK SITE CLEAN AND FREE FROM RUBBISH AND DEBRIS DURING CONSTRUCTION, INCLUDING SUSPENSION OF WORK, UNTIL FINAL ACCEPTANCE OF THE PROJECT.
- 16. CONTRACTOR MUST ABATE DUST NUISANCE BY CLEANING, SWEEPING, AND SPRINKLING WITH WATER AND USING DUST FENCES OR OTHER METHODS IN ACCORDANCE WITH THE CONTRACT DOCUMENTS AND AS DIRECTED BY THE CITY ENGINEER THROUGHOUT THE CONSTRUCTION OPERATION.
- 17. ALL DAMAGE CAUSED TO PUBLIC STREETS, INCLUDING HAUL ROUTES, ALLEYS, SIDEWALKS, CURBS, STREET FURNISHINGS, OR TO PRIVATE PROPERTY THAT IS OUTSIDE THE DEMOLITION LIMITS MUST BE REPAIRED AT THE SOLE EXPENSE OF THE CONTRACTOR TO THE ENGINEER'S SATISFACTION.
- 18. SAWCUTTING OF EXISTING PAVEMENT MUST BE TO A CLEAN STRAIGHT EDGE AS DIRECTED BY THE CITY INSPECTOR.
- 19. ALL SUBSURFACE WORK MUST BE PERFORMED IN ACCORDANCE WITH THE REQUIREMENTS AND RECOMMENDATIONS CONTAINED IN THE GEOTECHNICAL REPORT PERFORMED BY ENGEO, INC., AND IN ACCORDANCE WITH THE PROJECT SPECIFICATIONS.

ABBREVIATIONS

A/C	ASDPHALT CONCRETE		
Adj	ADJUST		
AP	ANGLE POINT	INT	INTERSECTION
APN	ASSESSOR PARCEL NUMBER	LOL	LAYOUT LINE
APWA	AMERICAN PUBLIC WORKS ASSOCIATION	Lt	LEFT
ASPH	ASPHALT	MBX	MAILBOX
B.O.	BLOW OFF	OG	ORIGINAL GROUND
BC	BEGIN CURVE	PKWY	PARKWAY
BCR	BEGIN CURB RETURN	PP	POWER POLE
BFV	BACK FLOW VALVE	PVI	POINT OF VERTICAL INTERSECTION
BVCE	BEGIN VERTICAL CURVE ELEVATION	PVIE	POINT OF VERTICAL INTERSECTION ELEVATION
BVCS	BEGIN VERTICAL CURVE STATION	PVIS	POINT OF VERTICAL INTERSECTION STATION
CB	CATCH BASIN	RD	ROAD
COD	CURB OUTLET DRAIN	Rel	RELOCATE
COM	COMMUNICATIONS	Rmv	REMOVE
CONST	CONSTRUCTION	Rplc	REPLACE
CW	CROSSWALK	Rt	RIGHT
DWG	DRAWING	RSP	REVISED STANDARD PLAN
EC	END CURVE	R/W	RIGHT OF WAY
ECP	ELECTRICAL CONTROL PANEL	SCE	SOUTHERN CALIFORNIA EDISON
ECR	END CURB RETURN	SC	SAWCUT
EL		SCG	SOUTHERN CALIFORNIA GAS COMPANY
EMT	ELECTRIC, ELECTRICAL ELECTRIC METER	SL	STREET LIGHT
EM I EP		SPPWC	STANDARD PLANS FOR PUBLIC WORKS
	EDGE OF PAVEMENT		CONSTRUCTION (GREENBOOK BY APWA)
ETC.	ET CETERA	SR	STATE ROUTE
EVCE	END VERTICAL CURVE STATION	SS	SANITARY SEWER
EVCS	END VERTICAL CURVE STATION	SSP	STATE STANDARD PLAN
EX	EXISTING EDOLTIED COMMUNICATIONS	SW	SIDEWALK
FC	FRONTIER COMMUNICATIONS	SYC	SYCAMORE
FL	FLOW LINE	TC	TOP OF CURB
GB	GRADE BREAK	TCE	TEMPORARY CONSTRUCTION EASEMENT
GM	GAS METER	TF	TOP OF FOUNDATION
GS	GROUND SURFACE	TSB	TRAFFIC SIGNAL BOX
GTD	GOLETA TRAIN DEPOT	TSP	TRAFFIC SIGNAL POLE
GV	GAS VALVE	TSPB	TRAFFIC SIGNAL PULL BOX
GWD	GOLETA WATER DISTRICT	TW	TOP OF WALL
HOA	HOME OWNER ASSOCIATION	UP	UTILITY POLE
HMA	HOT MIX ASPHALT	Var	VARIABLE
ICV	IRRIGATION CONTROL VALVE	WPJt	WEAKENED-PLANE JOINT
		01	

UTILITY INFORMATION

CITY OF GOLETA
GERALD COMATI
808-962-0488

COX COMMUNICATIONS **CARL.GIVENS** CARL.GIVENS@COX.COM

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GOLETA WATER DISTRICT (GWD) DAN BROOKS

DBROOKS@GOLETAWATER.COM

SOUTHERN CALIFORNIA EDISON (SCE) MASPREQUESTS@SCE.COM

SOUTHERN CALIFORNIA GAS (SCG) JOEL CANIZALEZ

NORTHWESTDISTRIBUTIONUTILITYREQUEST@SEMPRAUTILITIES.COM

LEGEND


CALTRANS STANDARD PLANS A10A, A10B AND A10C AND SUPPLEMENTED WITH:

NEW STORM DRAIN

EXISTING OVERHEAD WIRE
EXISTING TELEPHONE
EXISTING ELECTRICAL
EXISTING CABLE
EXISTING FIBER OPTIC
EXISTING NATURAL GAS
EXISTING WATER
EXISTING SEWER
EXISTING STORM DRAIN
NEW OVERHEAD WIRE
NEW TELEPHONE
NEW ELECTRICAL
NEW CABLE
NEW FIBER OPTIC
NEW NATURAL GAS
NEW WATER
NEW SEWER

UTILITY ADJUSTMENTS

OBJECT	SHEET NO.	STA/OS	Adj/ Rel	BY OWNER	BY CONTRACTOR
WATER VALVE	DM-01	22+74.09 16.63' Lt	Adj	GWD	
WATER VALVE	DM-01	22+78.00 26.77' Rt	Adj	GWD	
WATER VALVE	DM-01	22+89.73 24.93' Rt	Adj	GWD	
TRAFFIC SIGNAL PULL BOX	DM-01	22+95.53 37.36' Rt	Adj		1
TRAFFIC SIGNAL PULL BOX	DM-01	23+10.46 33.78' Rt	Adj		1
WATER METER	DM-01	24+53.50 23.94' Rt	Adj	GWD	
HYDRANT	DM-01	25+01.15 28.14' Rt	Adj	GWD	
GAS VALVE	DM-01	25+95.15 16.05' Lt	Adj	SCG	
IRRIGATION VALVE	DM-01	26+59.24 28.77' Lt	Rel	PROPERTY OWNER	
WATER METER	DM-02	28+41.37 27.88' Lt	Adj	GWD	
VAULT	DM-02	28+63.68 14.58' Rt	Adj	SCE	
WATER METER	DM-02	30+41.70 28.26' Lt	Adj	GWD	
HYDRANT	DM-02	30+41.83 28.57' Rt	Rel	GWD	
WATER VALVE	DM-02	30+41.90 25.74' Rt	Adj	GWD	
MONITOR WELL	DM-02	31+43.82 9.73' Rt	Adj		1
MONITOR WELL	DM-02	31+49.53 9.85' Rt	Adj		1
HOSE BID	DM-02	31+73.48 28.76' Lt	Rel	PROPERTY OWNER	
WATER VALVE	DM-02	32+13.40 23.15' Rt	Adj	GWD	
PULL BOX	DM-02	32+33.61 27.19' Lt	Adj	COX	
VAULT	DM-02	32+37.21 23.08' Lt	Adj	COX	
BACK FLOW VALVE	DM-03	33+73.17 25.67' Lt	Rel	PROPERTY OWNER	
WATER METER	DM-03	33+73.95 22.80' Lt	Adj	GWD	
MAILBOX	DM-03	33+82.77 26.50' Lt	Rel	PROPERTY OWNER	
WATER VALVE	DM-03	34+13.17 22.87' Rt	Adj	GWD	
WATER VALVE	DM-03	34+14.59 24.27' Rt	Adj	GWD	
SEWER MAINTENANCE HOLE	DM-03	34+41.60 0.79' Rt	Adj	GSD	
WATER VALVE	DM-03	34+41.83 25.59' Rt	Adj	GWD	
HYDRANT	DM-03	34+41.89 28.17' Rt	Adj	GWD	
WATER VALVE	DM-03	34+47.78 25.44' Rt	Adj	GWD	
POLE	DM-03	34+63.38 24.46' Lt	Rel	FRT	
PULL BOX	DM-03	34+84.38 23.65' Lt	Adj	SCE	
MONITOR WELL	DM-03	35+14.94 22.32' Rt	Adj		1
MAILBOX	DM-03	35+53.81 28.66' Lt	Rel	PROPERTY OWNER	
POLE	DM-03	35+76.12 27.92' Lt	Rel	FRT	
CONDUIT	DM-03	35+76.12 24.50' Lt	Rel	COX	
WATER METER	DM-03	36+50.80 29.67' Lt	Adj	GWD	
VAULT	DM-03	37+87.97 22.93' Lt	Adj	FRT	
WATER VALVE	DM-03	38+24.93 13.30' Rt	Adj	GWD	

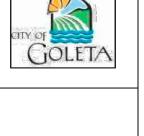

PUBLIC WORKS DEPARTMENT **ENGINEERING DIVISION**

4

SOUTH IMPROV

PBW NO. BID NO. SHT. DES **GN-01** SHEET 3 OF 40

02/06/24 SHAWN KOWALEWSKI PROJECT ENGINEER:

LOC	AL CONTR	OL & FOUN	ID MONU	JMENTS (US SURVEY FEET)
1	1985042.71	6006499.53	13.64	CP SCRIBE X SWK
2	1985548.94	6006365.68	20.91	CP 60D NL+SHNR
3	1986156.29	6006309.33	31.37	CP SCRIBE X SWK
4	1986559.78	6006227.68	36.34	CP MAG NL
5	1986801.98	6006179.81	32.14	CP SCRIBE X CNC
6	1986561.43	6006074.20	36.85	CP MAG NL SBS AP
7	1986516.70	6005816.25	33.46	CP 8 MAG AC
8	1986600.71	6005735.73	32.13	CP SCRIBE X CNC
9	1986565.43	6005904.14	35.6	CP MAG NL AC
10	1986760.34	6005914.70	34.2	CP MAG NLAC
11	1986675.69	6006109.22	35.13	CP MAG NL+FLAG
20	1984891.57	6006471.80	10.071	CP 60D NL+WHSKR
21	1985173.97	6006432.78	15.004	CP SCRIBE X SWK
22	1985757.16	6006373.72	25.308	CP SCRIBE X SWK
23	1985999.44	6006290.03	29.34	CP SCRIBE X TC
201	1984925.24	6006527.31	13.74	MONF 3/4IP+TAG
202	1985039.48	6006507.53	13.64	MONF N+T LS7911
203	1985433.42	6006439.19	18.55	MONF 2I IP+T RCE 7211
204	1986076.32	6006327.76	29.97	MONF 2I IP+TAG RCE 7211
310	1985416.86	6006432.23	19.119	MONF N&T TC SBCO SURVEYOR
311	1985447.77	6006426.93	19.705	MONF N&T TC SBCO SURVEYOR
371	1985187.20	6007950.80	15.8	MONF 3.5IBC EW3777

SURVEY CONTROL SUMMARY


BASIS OF BEARINGS & MEASUREMENTS

THE BEARING OF NORTH 09°50'05" WEST WAS USED BETWEEN FOUND MONUMENTS ALONG THE EAST LINE OF LA PATERA LANE AS SHOWN ON PARCEL MAP NO. 20,608, RECORDED IN BOOK 54, PAGES 63-69 PER SANTA BARBARA COUNTY RECORDS. THE MEASURED DISTANCES FOR THE PROJECT ARE GROUND DISTANCES.

BASIS OF ELEVATIONS

ELEVATIONS ARE BASED ON THE NGS FOUND MONUMENT, EW3777 RECORDED ON THE AIRPORT SURVEY CONTROL NETWORK PER SANTA BARBARA COUNTY RECORDS, BOOK 170, PAGES 63-65 ON THE NAVD88 DATUM.

DESIGNATION EW3777, ELEV. = 15.80' (POINT 371)

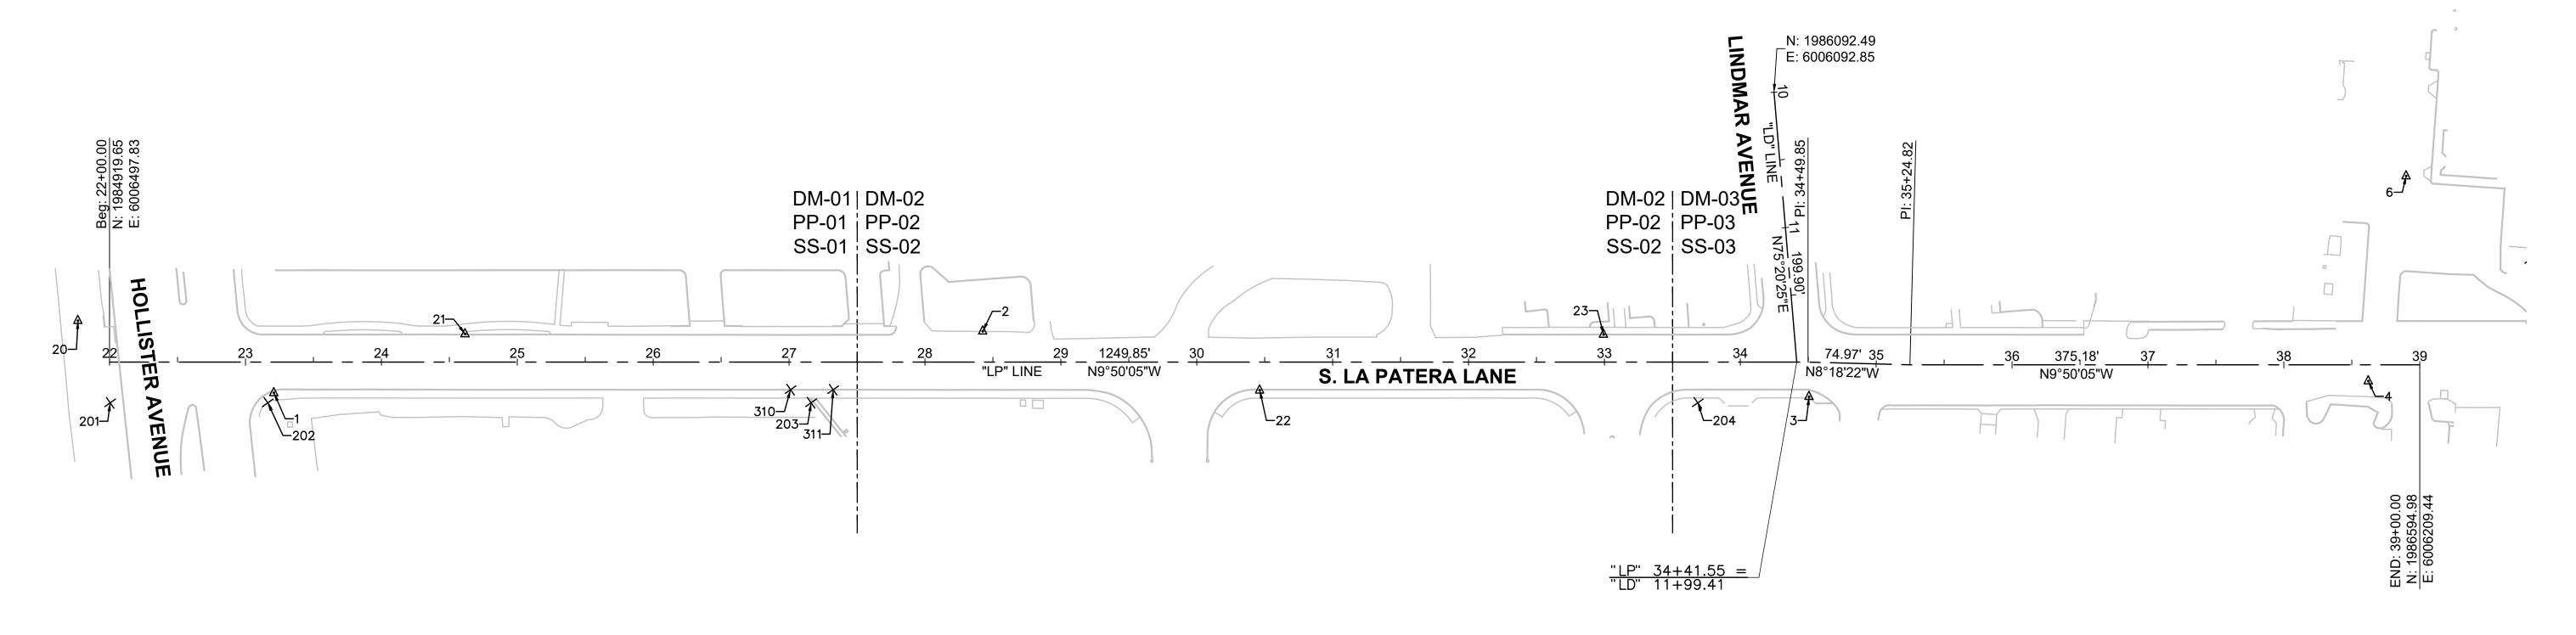

SIGN: GD APPROVED:

AWN: GD APPROVED:

SK DEPARTMENT BENDING SYNON SIGNEER

ORIGINAL SIGNED DATE

ORIGINAL SIGNED DATE

ORIGINAL SIGNED DATE

3/4/2

SOUTH LA PATERA LANE
IMPROVEMENT PROJECT

SCALE: 1" = 60'

SCALE: 1" = 60'

SHAWN

KOWALEWSKI

No. 59539

Exp. 12/31/25

CIVIL

DATE

OF CAL FORM

OF C

SHAWN KOWALEWSKI

PROJECT ENGINEER:

PBW NO.

BID NO. SHT. DES

PC-01

DWG NO.

SHEET 4 OF 40

12. SECTIONS OF ADJOINING SIDEWALK MAY BE DEPRESSED TO MAKE AN ADA

COMPLIANT TRANSITION TO THE DRIVEWAY. RETAINING CURBS MAY BE

NECESSARY.

7. BACK-OF-SIDEWALK TRANSITIONS AT RETAINING CURBS MUST BE 4:1

8. EXPANSION JOINTS MUST BE MADE WITH CALTRANS APPROVED 1/2 INCH THICK

EXPANSION FILLER PAPER PLACED AT THE BEGINNING AND END OF EACH CURB

LONGITUDINAL TO TRANSVERSE.

20

4

3/

 \Box

SEC

PBW NO.

BID NO. SHT. DES

TYP-01

DWG NO.

SHEET 5 OF 40

SHAWN

KOWALEWSKI

No. 59539

02/06/24

DATE

SHAWN KOWALEWSKI

PROJECT ENGINEER:

Exp. 12/31/25 /

PBW NO.

BID NO. SHT. DES.

DM-01

DWG NO.

SHEET 6 OF 40

SHAWN

 $^{'}$ KOWALEWSKI $^{\lor}$


No. 59539

02/06/24 DATE

SHAWN KOWALEWSKI

PROJECT ENGINEER:

Exp. 12/31/25

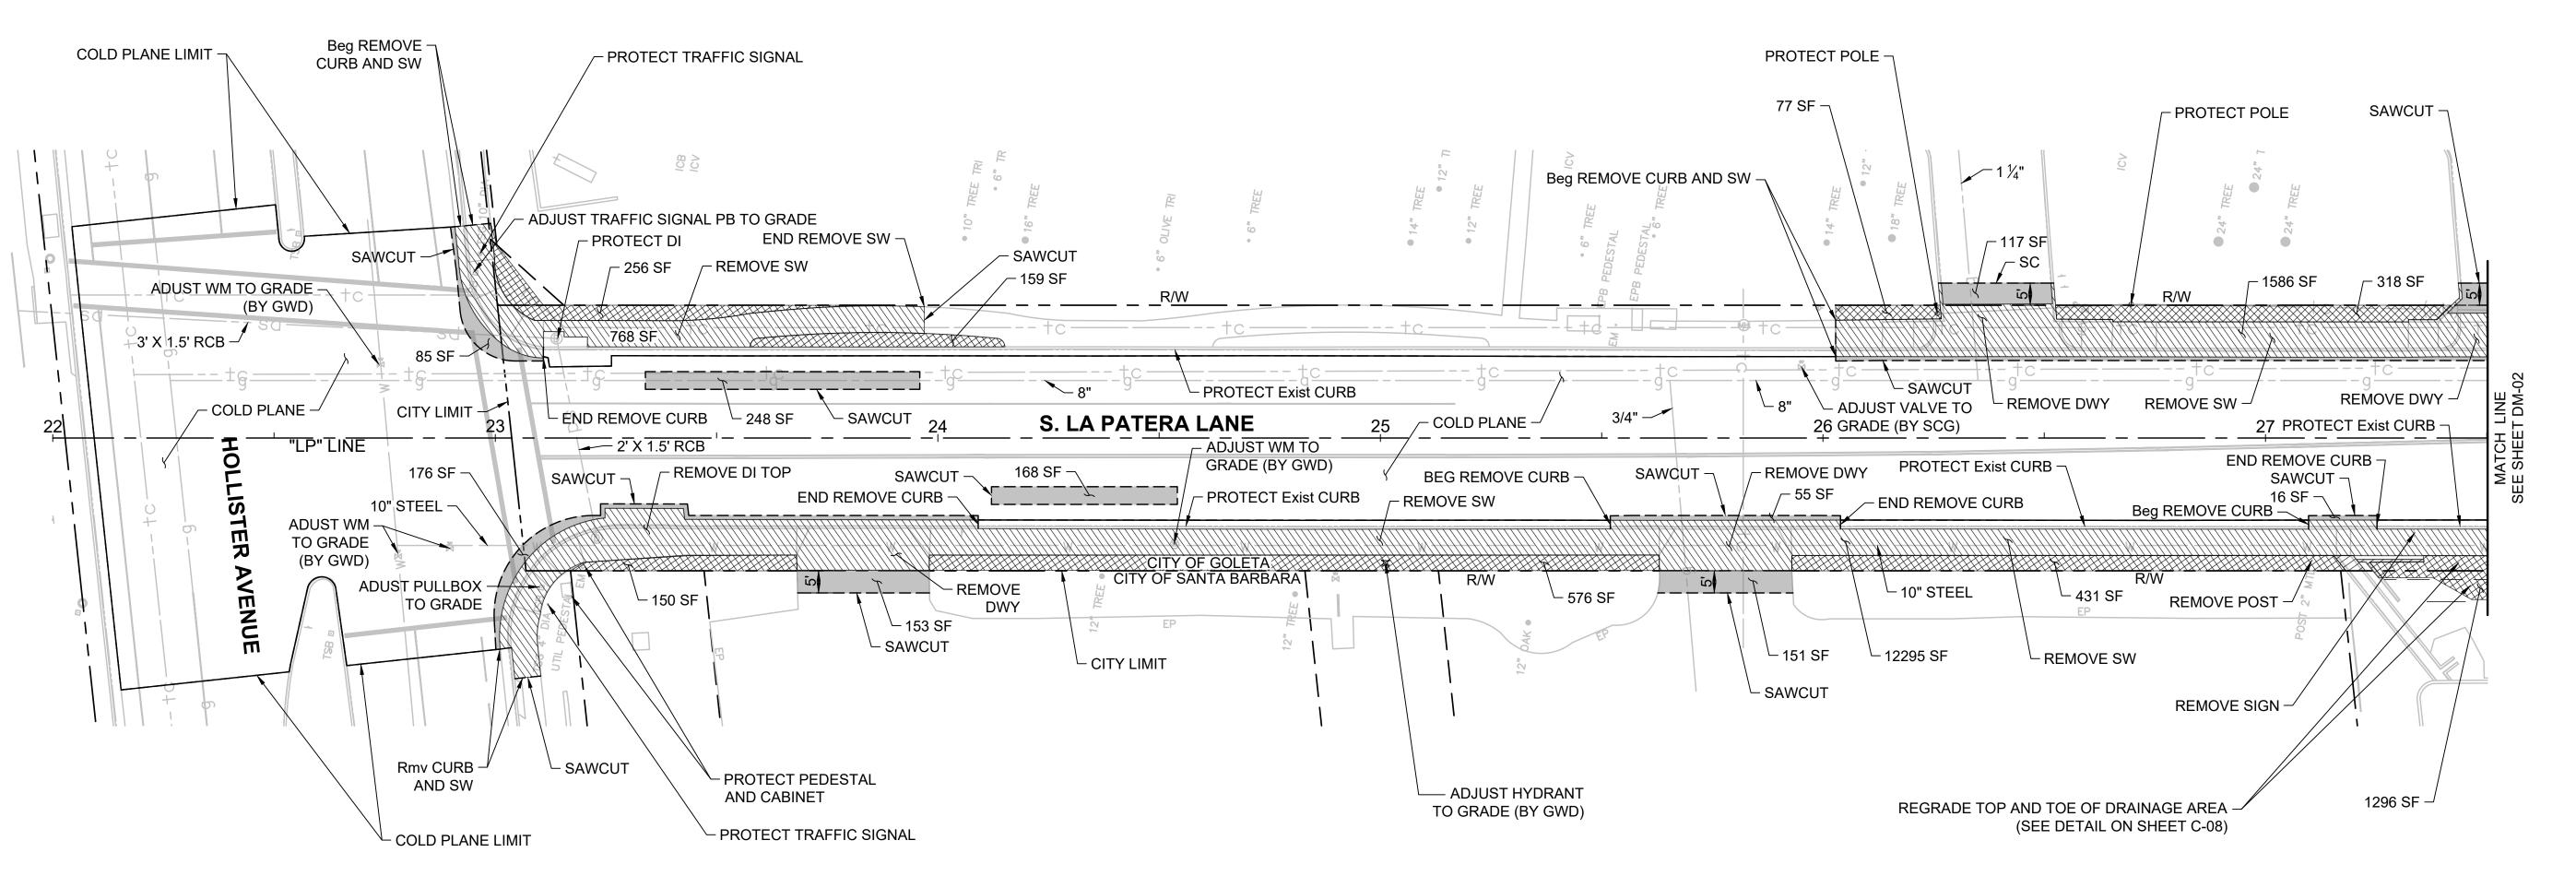

LEGEND

REMOVE CONCRETE

REMOVE AC

CLEARING AND GRUBBING

——— SAWCUT AND COLD PLANE LIMIT


PROJECT ENGINEER:

LEGEND

BID NO. SHT. DES.

DM-03

SHEET 8 OF 40

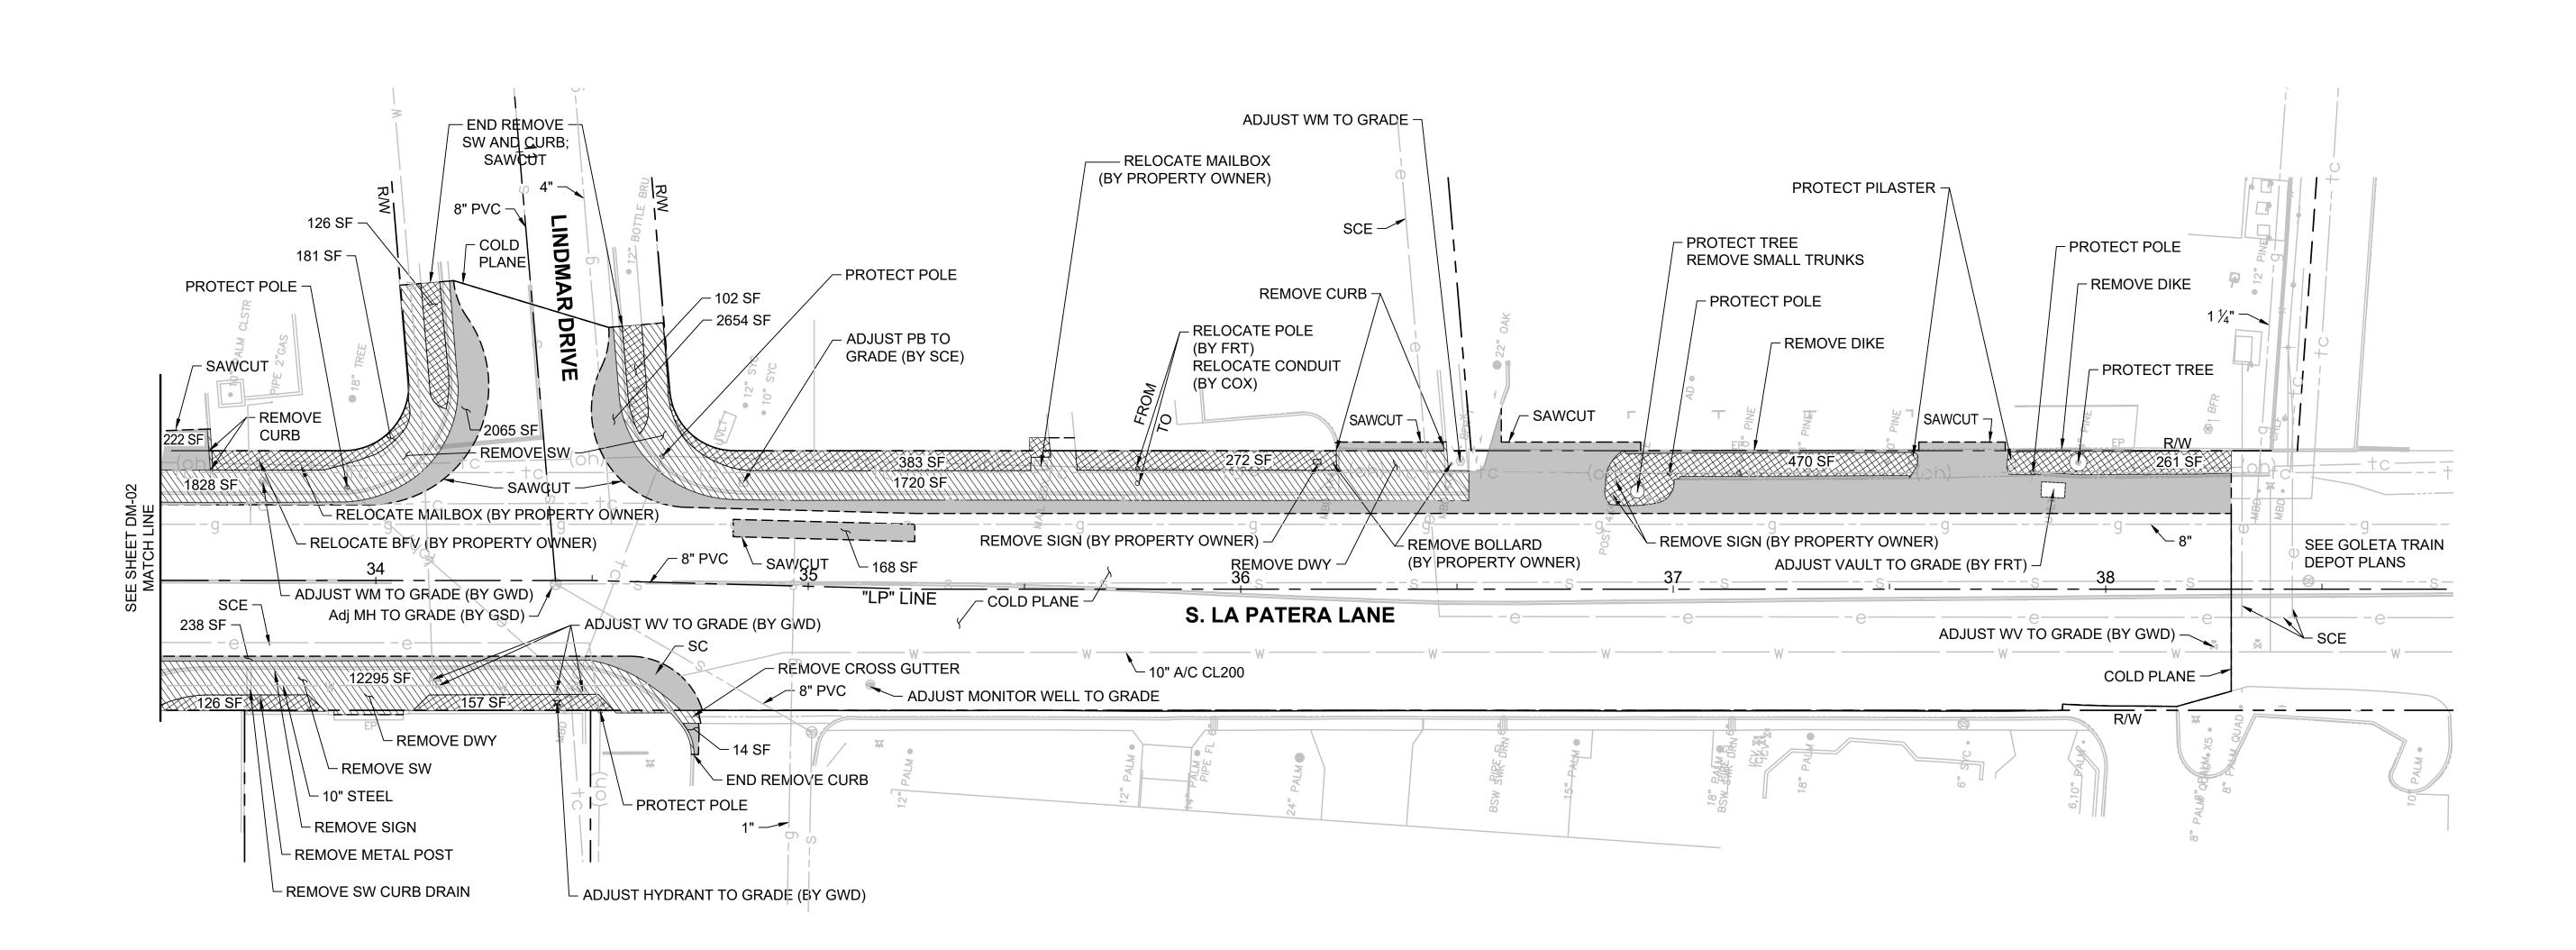

LEGEND


REMOVE CONCRETE


CLEARING AND GRUBBING


REMOVE AC

---- SAWCUT AND COLD PLANE LIMIT

SHAWN KOWALEWSKI
PROJECT ENGINEER:

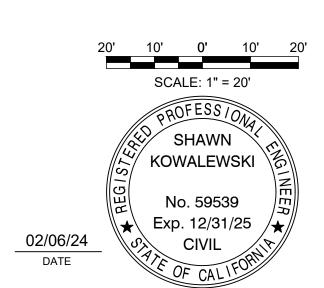

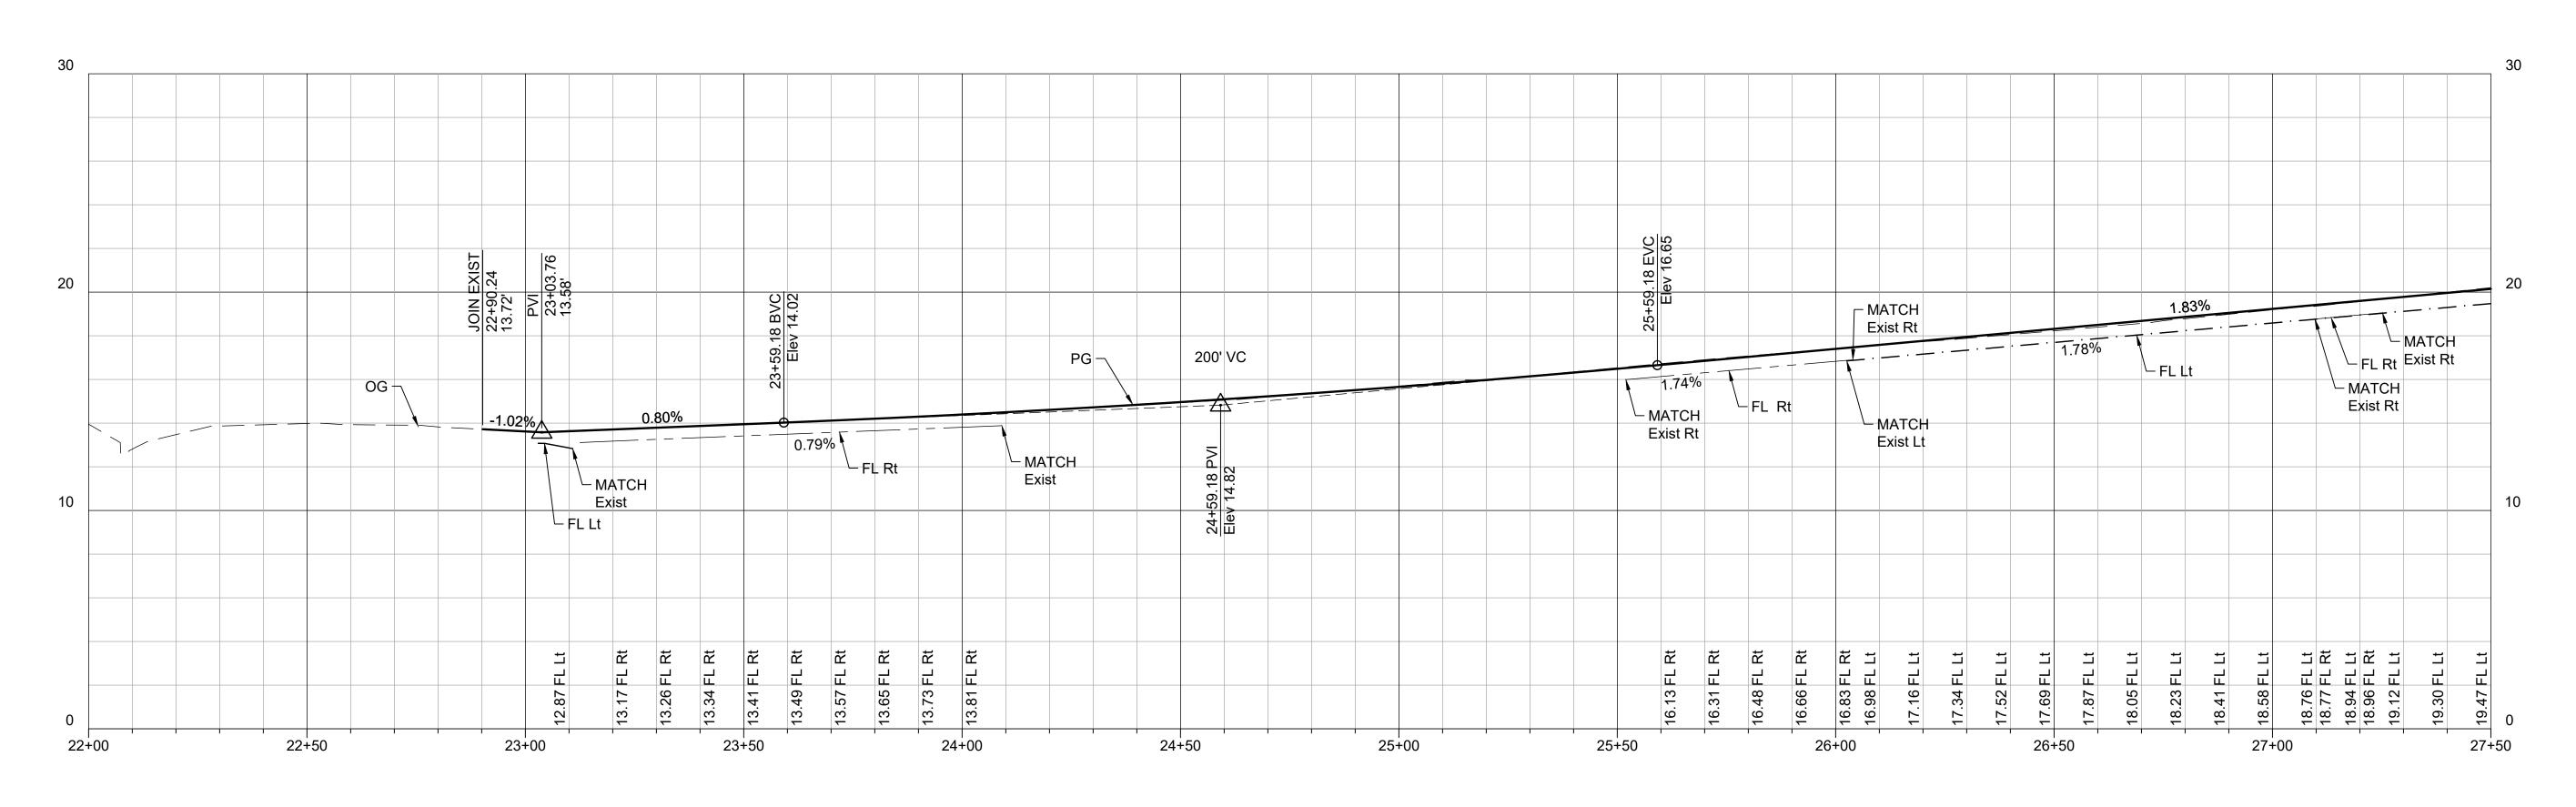


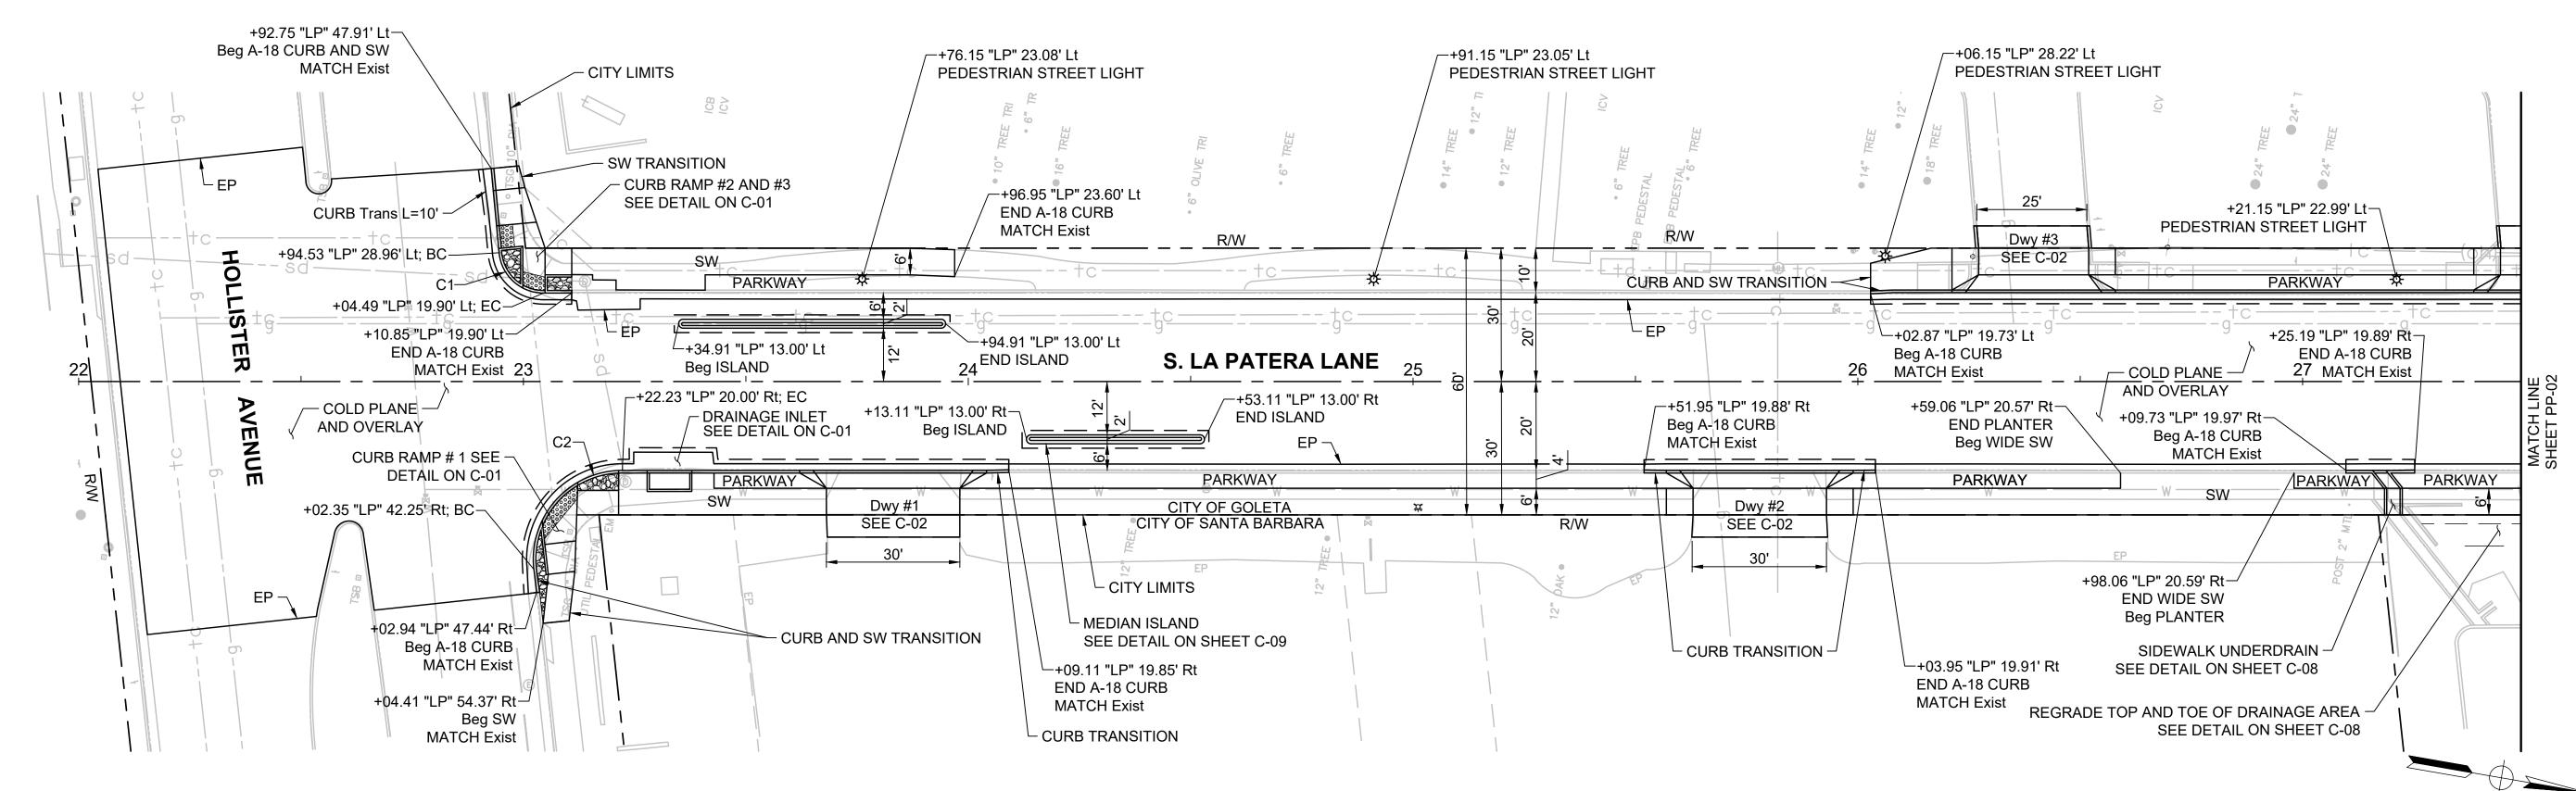

NOTES:

- 1. ADDITIONAL CONSTRUCTION DETAILS PROVIDED ON SHEETS C-01 TO C-09.
- 2. CURB AND SIDEWALK TRANSITIONS TO EXISTING FEATURES EXTEND OVER 5', UNLESS OTHERWISE NOTED.
- 3. CURB ALIGNMENT AND LAYOUT REFERENCES FLOW LINE, UNLESS OTHERWISE NOTED.
- 4. CURB DETAILS ON C-09.
- 5. SEE LANDSCAPE PLANS FOR PARKWAY DETAILS.



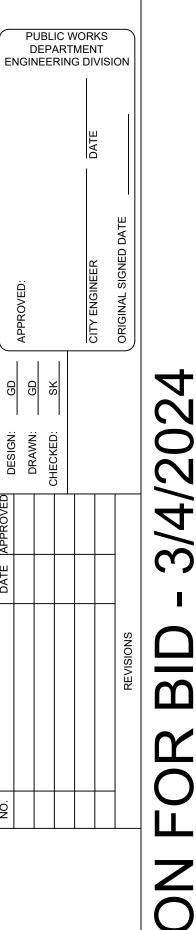

SOUTH I IMPROVI

PBW NO.

BID NO. SHT. DES.

PP-01

DWG NO.

SHEET 9 OF 40

Horiz SCALE: 1"=20'

Vert SCALE: 1"=20'


SHAWN


KOWALEWSKI

No. 59539

DATE

、Exp. 12/31/25 /★/

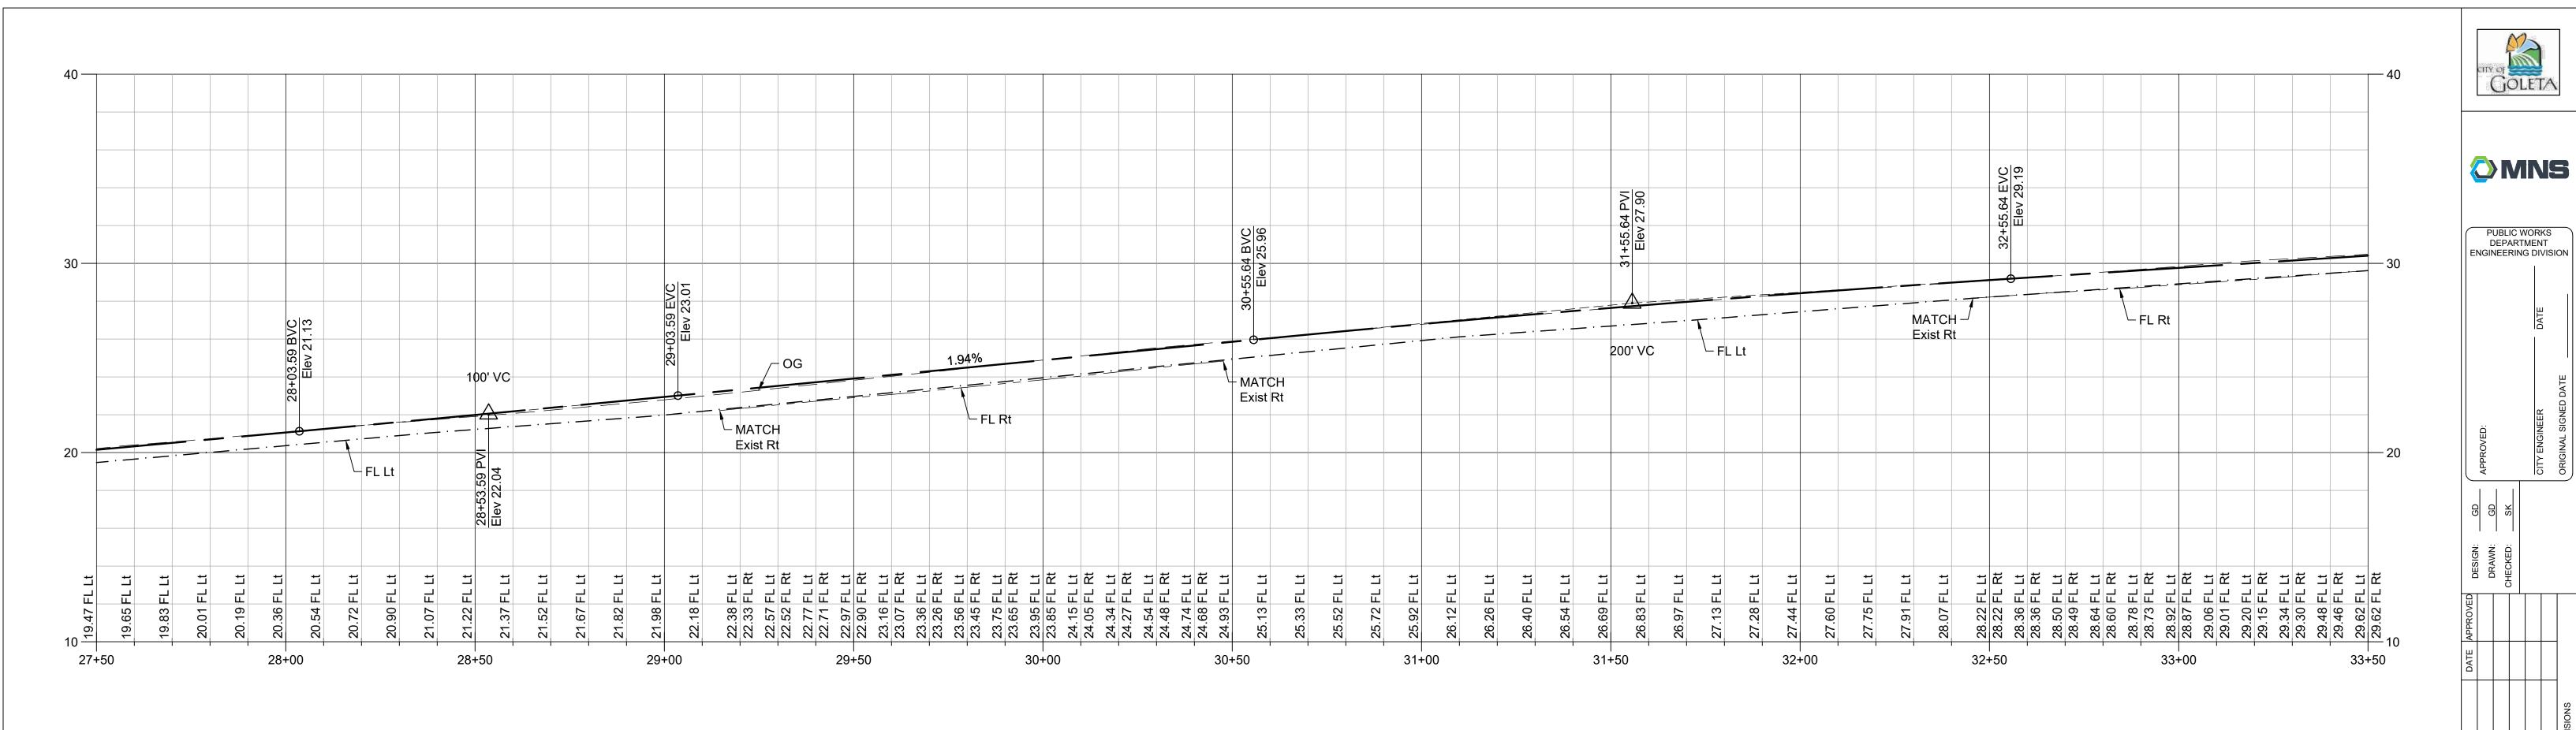


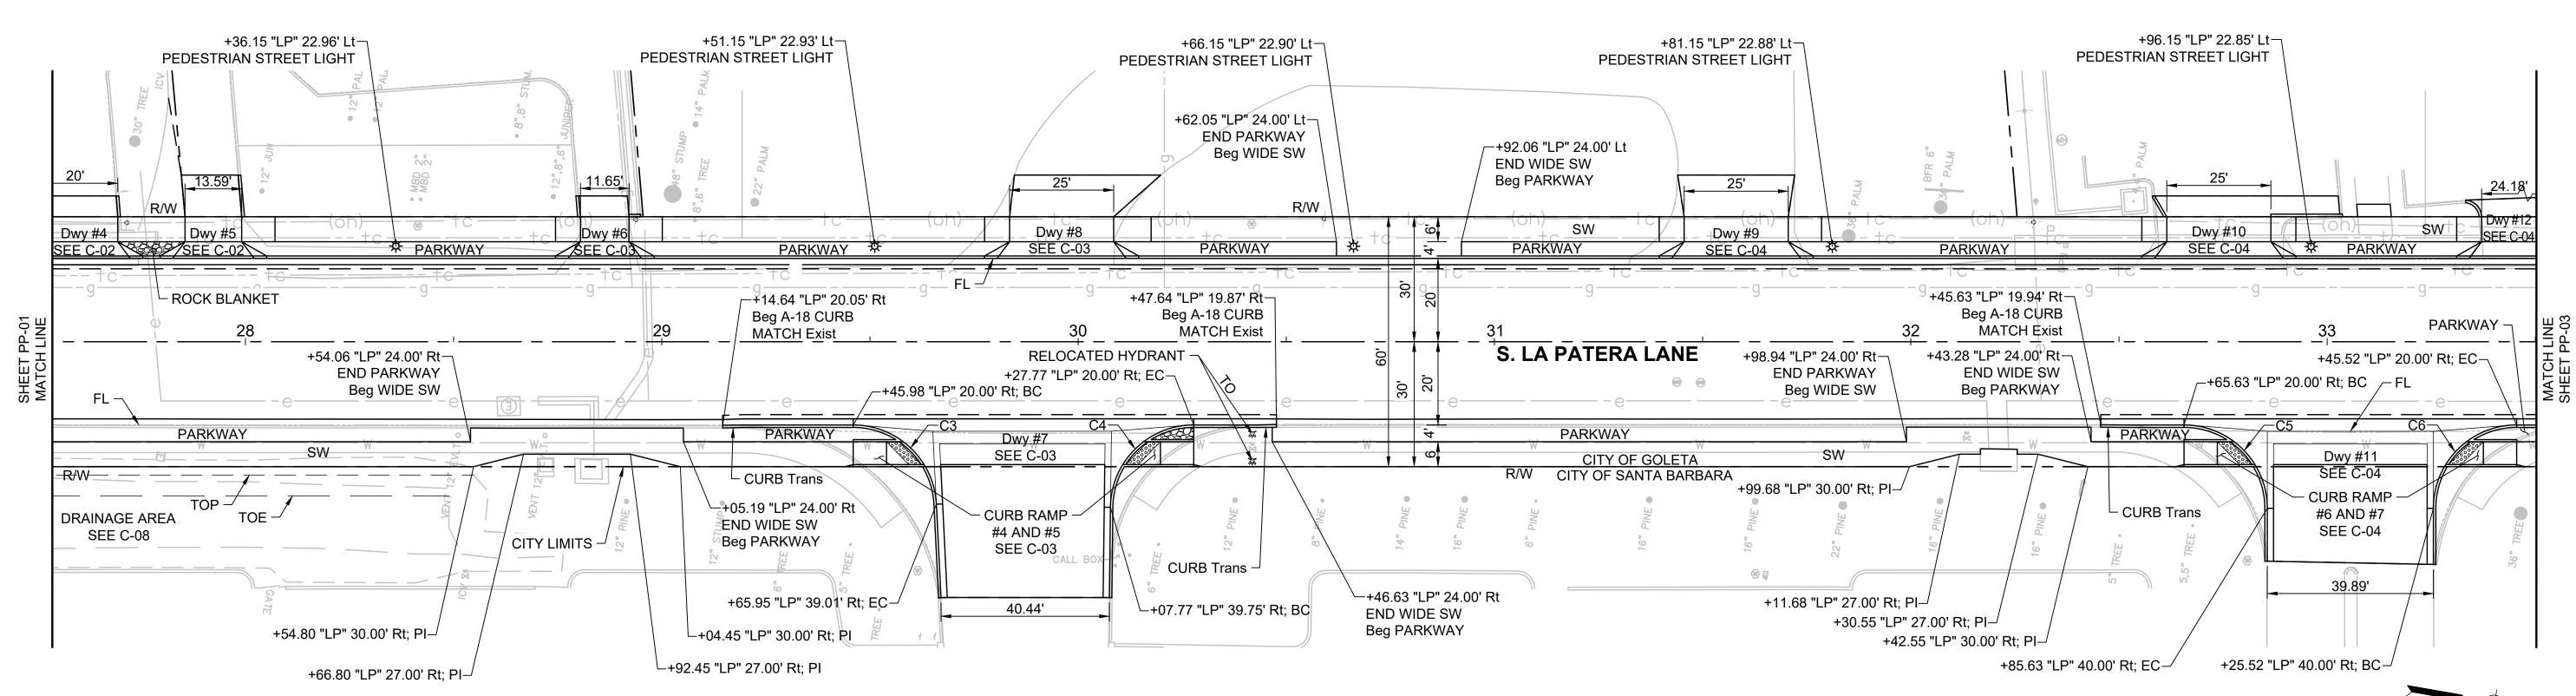

NOTES:

- 1. ADDITIONAL CONSTRUCTION DETAILS PROVIDED ON SHEETS C-01 TO C-09.
- 2. CURB AND SIDEWALK TRANSITIONS TO EXISTING FEATURES EXTEND OVER 5', UNLESS OTHERWISE NOTED.
- 3. CURB ALIGNMENT AND LAYOUT REFERENCES FLOW LINE, UNLESS OTHERWISE NOTED.
- 4. CURB DETAILS ON C-09.
- 5. SEE LANDSCAPE PLANS FOR PARKWAY DETAILS.

	CURVE DATA								
No.	L	R	DELTA	Tan					
C3	30.42	20.00'	87°09'30"	19.03'					
C4	31.17	20.00'	89°17'45"	19.76'					
C5	31.42	20.00'	90°00'00"	20.00'					
C6	31.42	20.00'	90°00'00"	20.00'					

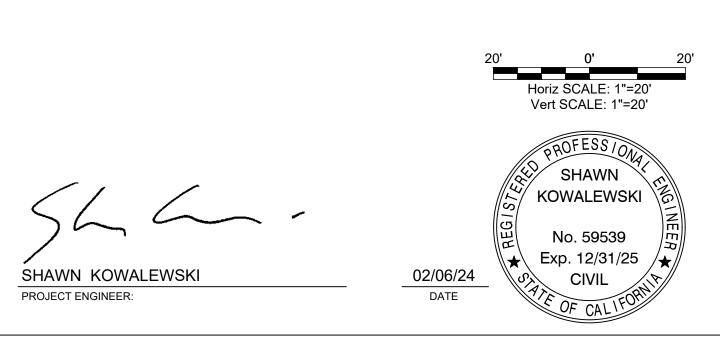

FILE REVISIONS AND - 3/4/2024 CITY ENGINEER DATE ORIGINAL SIGNED DATE


SOUTH IMPROV OADWAY


PBW NO.

BID NO. SHT. DES.

PP-02

SHEET 10 OF 40

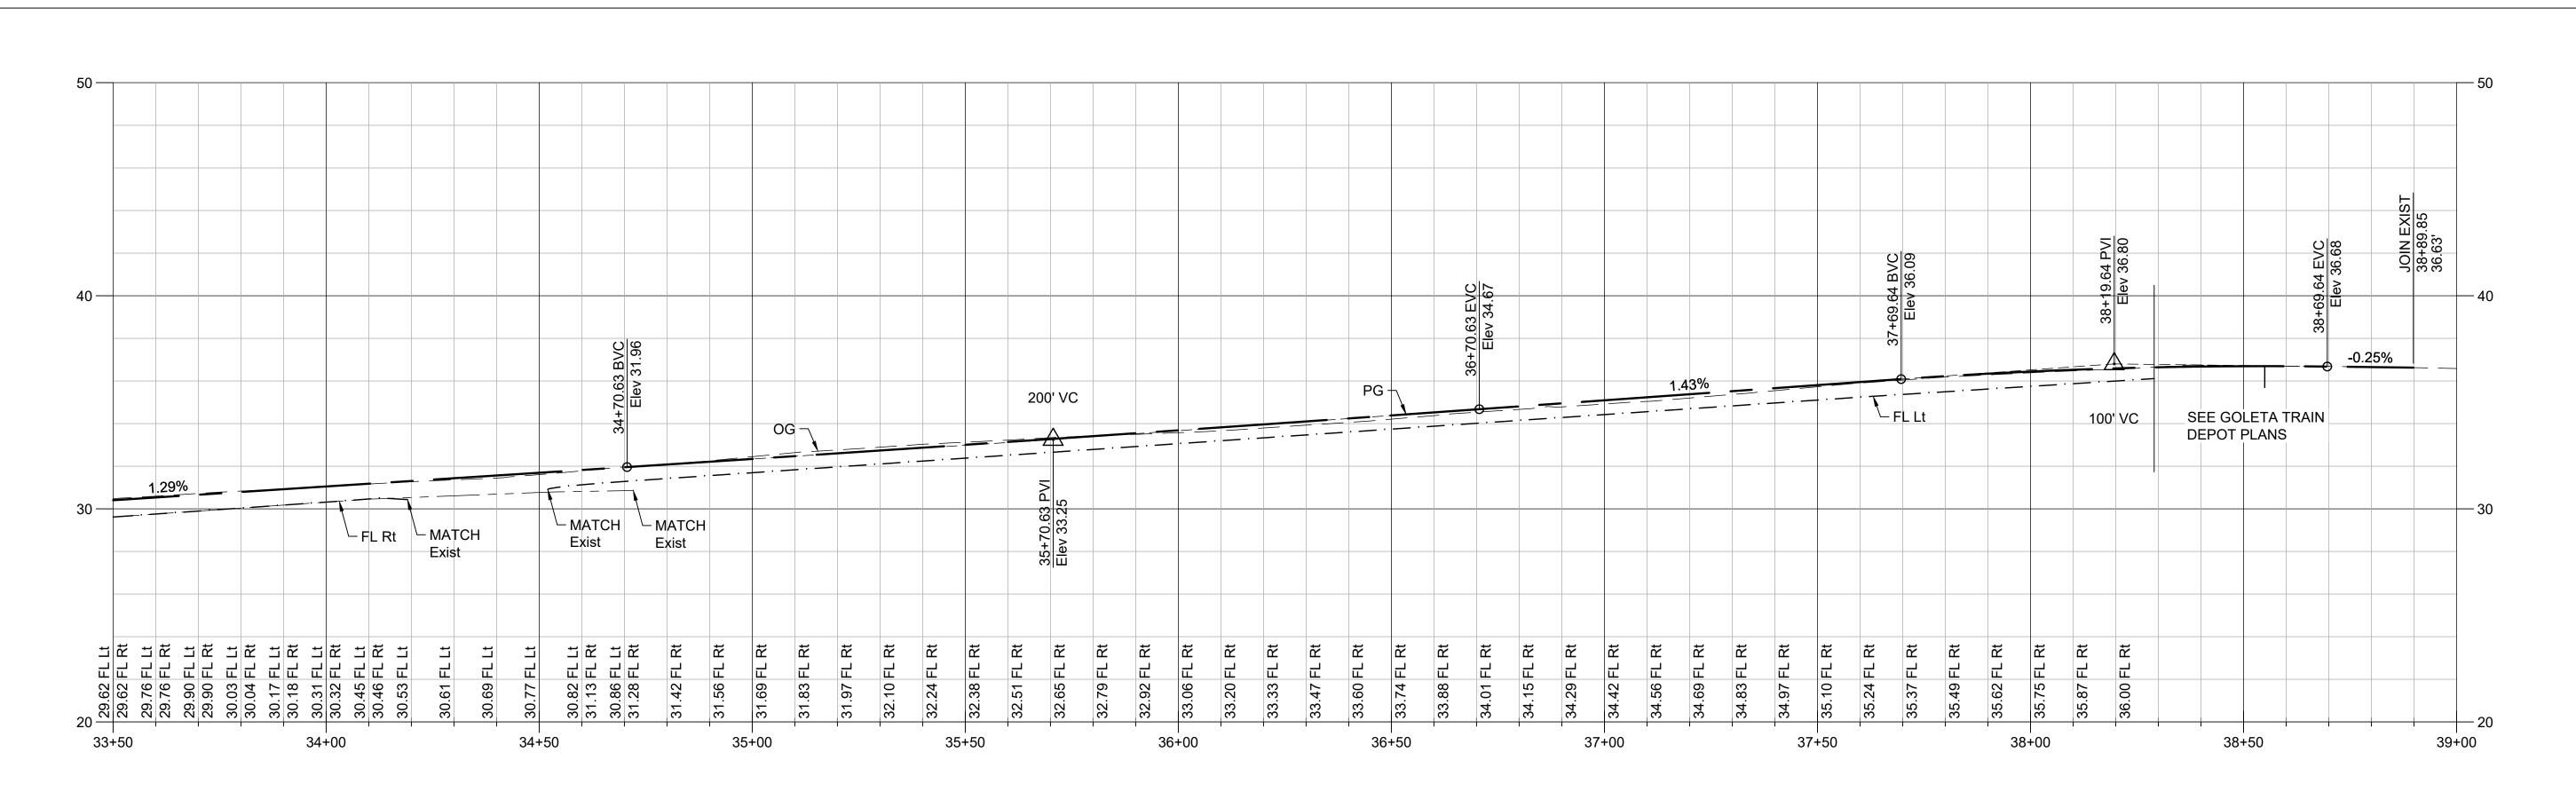

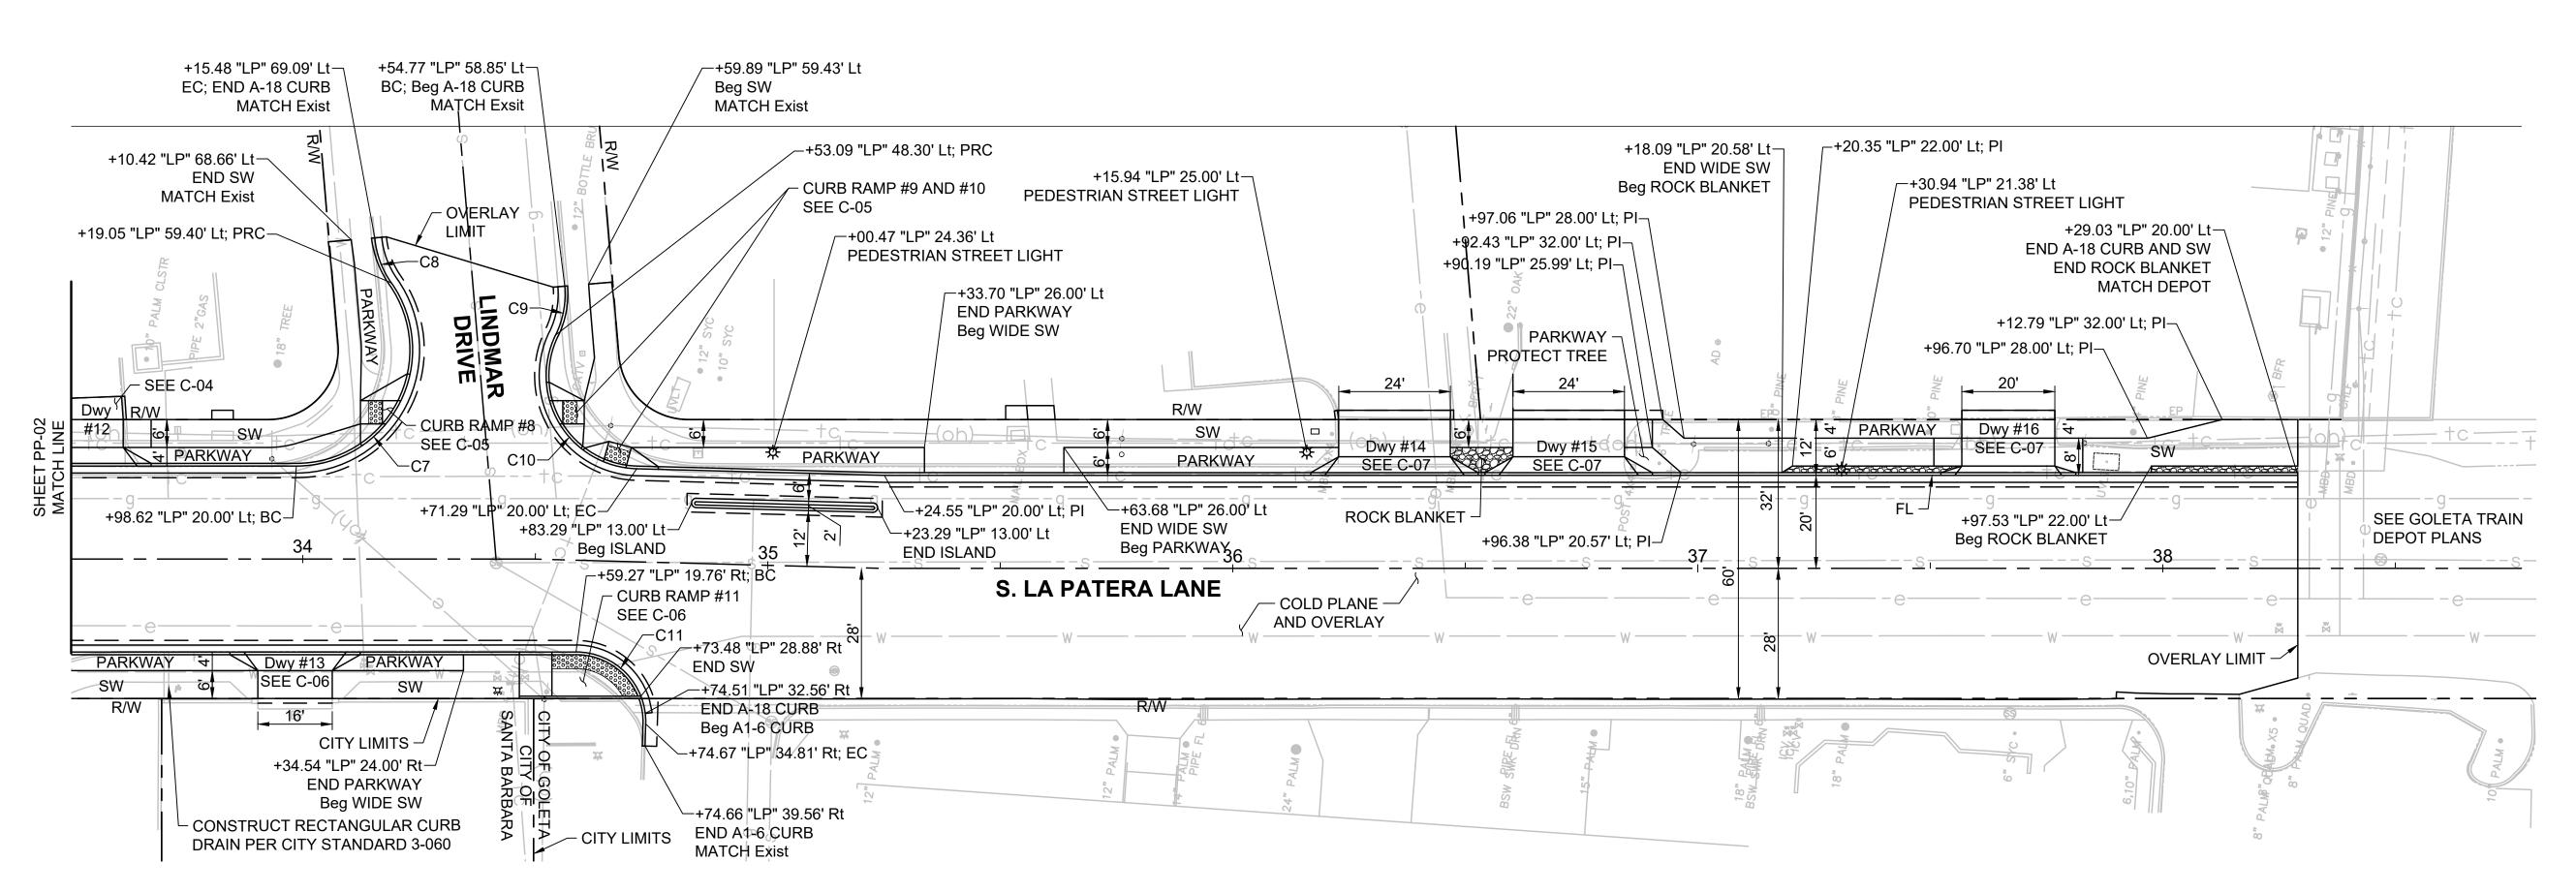



NOTES:


- 1. ADDITIONAL CONSTRUCTION DETAILS PROVIDED ON SHEETS C-01 TO C-09.
- 2. CURB AND SIDEWALK TRANSITIONS TO EXISTING FEATURES EXTEND OVER 5', UNLESS OTHERWISE NOTED.
- 3. CURB ALIGNMENT AND LAYOUT REFERENCES FLOW LINE, UNLESS OTHERWISE NOTED.
- 4. CURB DETAILS ON C-09.
- 5. SEE LANDSCAPE PLANS FOR PARKWAY DETAILS.

	CURVE DATA								
No.	L	R	DELTA	Tan					
C7	54.61	25.00'	125°09'45"	48.19'					
C8	10.44	20.00'	29°55'00"	5.34'					
C9	10.82	20.00'	30°59'15"	5.54'					
C9	10.82	20.00'	30°59'15"	5.54'					

CURVE DATA								
No. L R DELTA Tan								
C10	39.98	20.00'	114°31'30"	31.11'				
C11	24.02	15.00'	91°45'00"	15.47'				

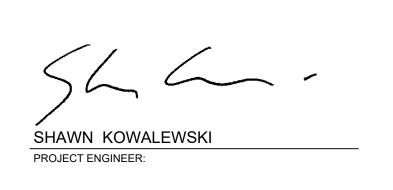

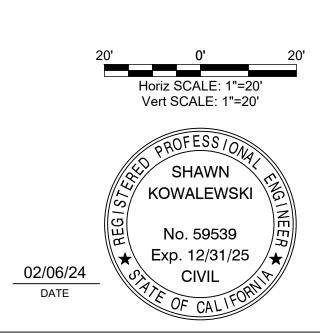

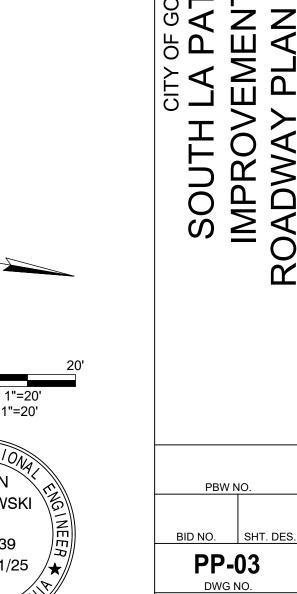

SHEET 11 OF 40

PUBLIC WORKS
DEPARTMENT
ENGINEERING DIVISION


3/4/20


GENERAL NOTES


- ROADSIDE SIGNS, PAVEMENT DELINEATION (STRIPING), MARKINGS, AND MARKERS MUST CONFORM TO THE LATEST EDITION OF CALTRANS STANDARD PLANS AND AND SPECIFICATIONS, AND THE LATEST EDITION OF THE CALIFORNIA MANUAL ON UNIFORM TRAFFIC CONTROL (CA-MUTCD).
- 2. PAVEMENT STRIPING AND MARKING MUST BE THERMOPLASTIC, UNLESS OTHERWISE NOTED.
- 3. REMOVE ALL EXISTING STRIPING AND PAVEMENT MARKINGS WHICH CONFLICT WITH NEW WORK SHOWN ON THE PLANS BY WET SANDBLASTING. SANDBLAST AREAS FOR PAVEMENT MARKING LEGEND AND ARROWS MUST BE RECTANGULAR.
- 4. CONSTRUCTION MATERIALS FOR ROADSIDE SIGN AND PAVEMENT DELINEATION WORK MUST BE FURNISHED AND INSTALLED BY THE CONTRACTOR.
- 5. LANE WIDTH SHOWN ON THE PLAN ARE DIMENSIONED FROM CURB FLOW LINE TO CENTER OF STRIPE OR TO THE STRIPE LAYOUT LINE (ETW).
- 6. CONTRACTOR MUST "CAT TRACK" PAVEMENT STRIPING AND MARKING AND FIELD MATCH FOR REVIEW AND APPROVAL BY CITY ENGINEER PRIOR TO FINAL SIGN AND STRIPING INSTALLATION.
- 7. THIS PLAN IS ACCURATE FOR SIGNING AND STRIPING WORK ONLY.

LEGEND

- SIGN IDENTIFICATION NUMBER
- STRIPING DETAIL NUMBER PER CALTRANS STANDARD PLANS A20A A20G
- 12" WIDE WHITE LIMIT LINE PER CALTRANS STANDARD PLAN A24G
- **ROADSIDE SIGN**
- CROSSWALK
- **REMOVE SIGN**
- RELOCATE SIGN
- RESET SIGN
- STREET NAME SIGN
- WHITE "STOP" PAVEMENT MARKING PER CALTRANS STANDARD PLAN A24D
- K72 WHITE REFLECTIVE FLEXIBLE BOLLARD
- BEGIN/END TRAFFIC STRIPE DETAIL

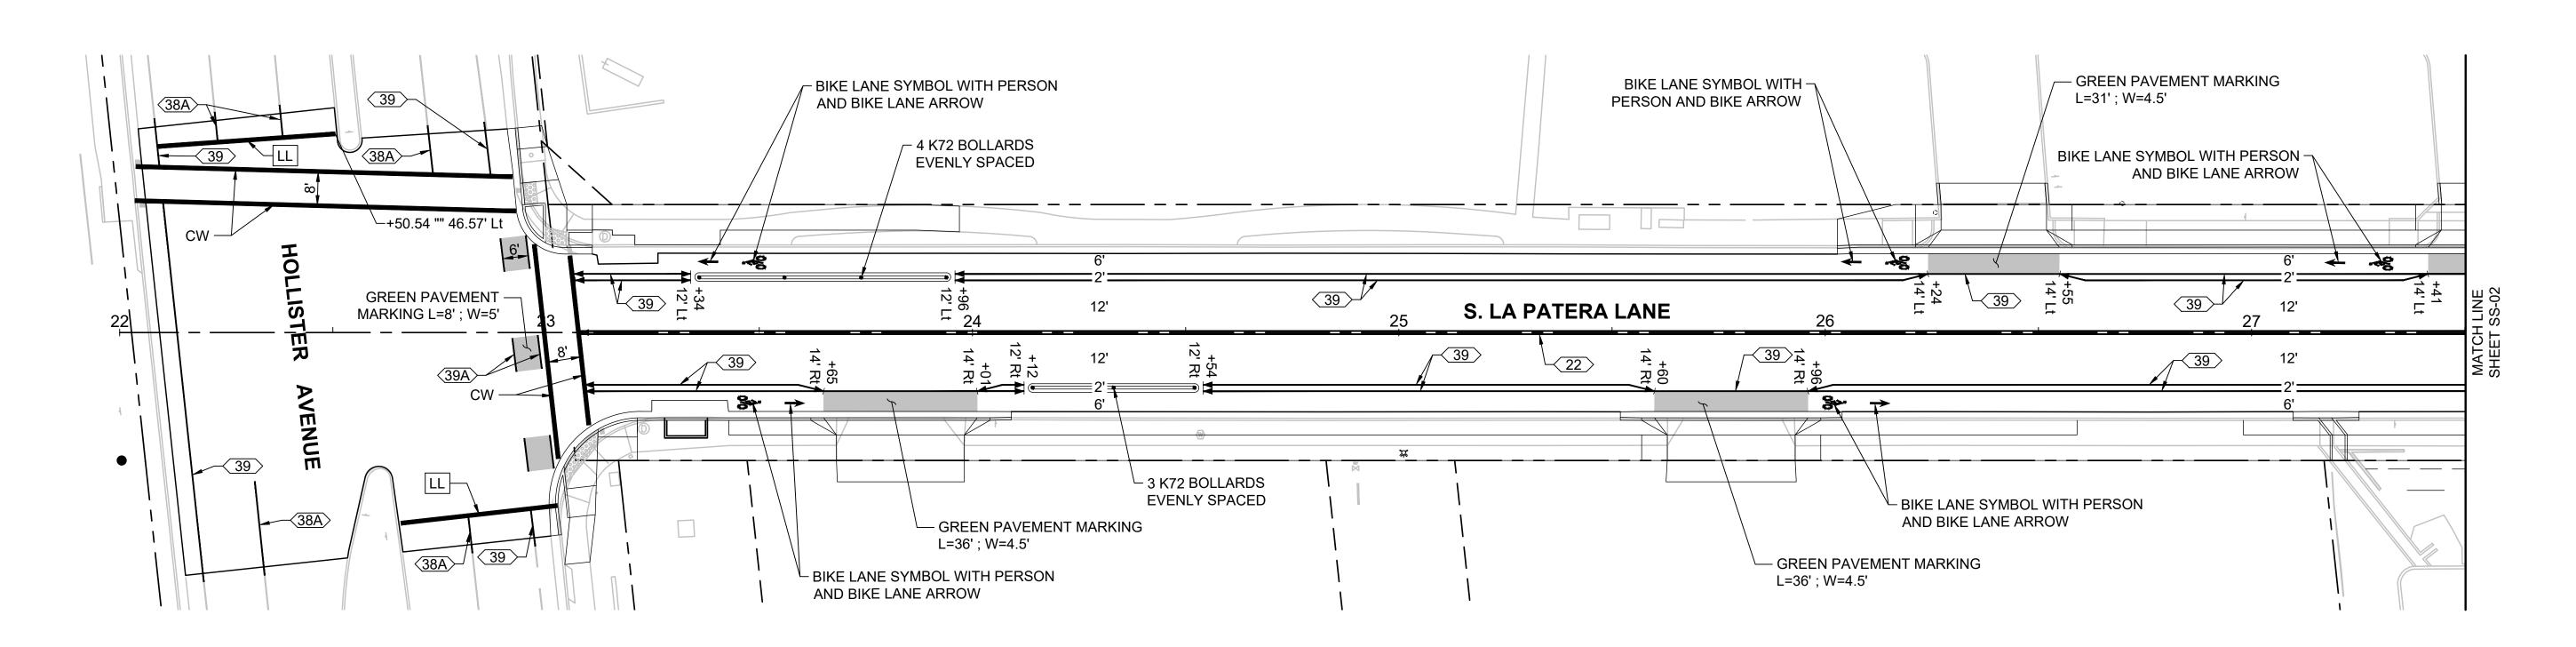

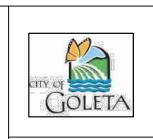

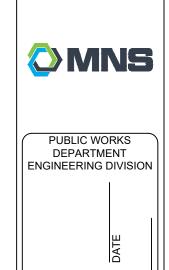

3/4/

SOUTH LA PATE IMPROVEMENT F SIGNING AND S

BID NO. SHT. DES. **SS-01** DWG NO.

SHEET 12 OF 40

SCALE: 1" = 20'


SHAWN KOWALEWSKI


No. 59539

Exp. 12/31/25

02/06/24 DATE

SHAWN KOWALEWSKI PROJECT ENGINEER:

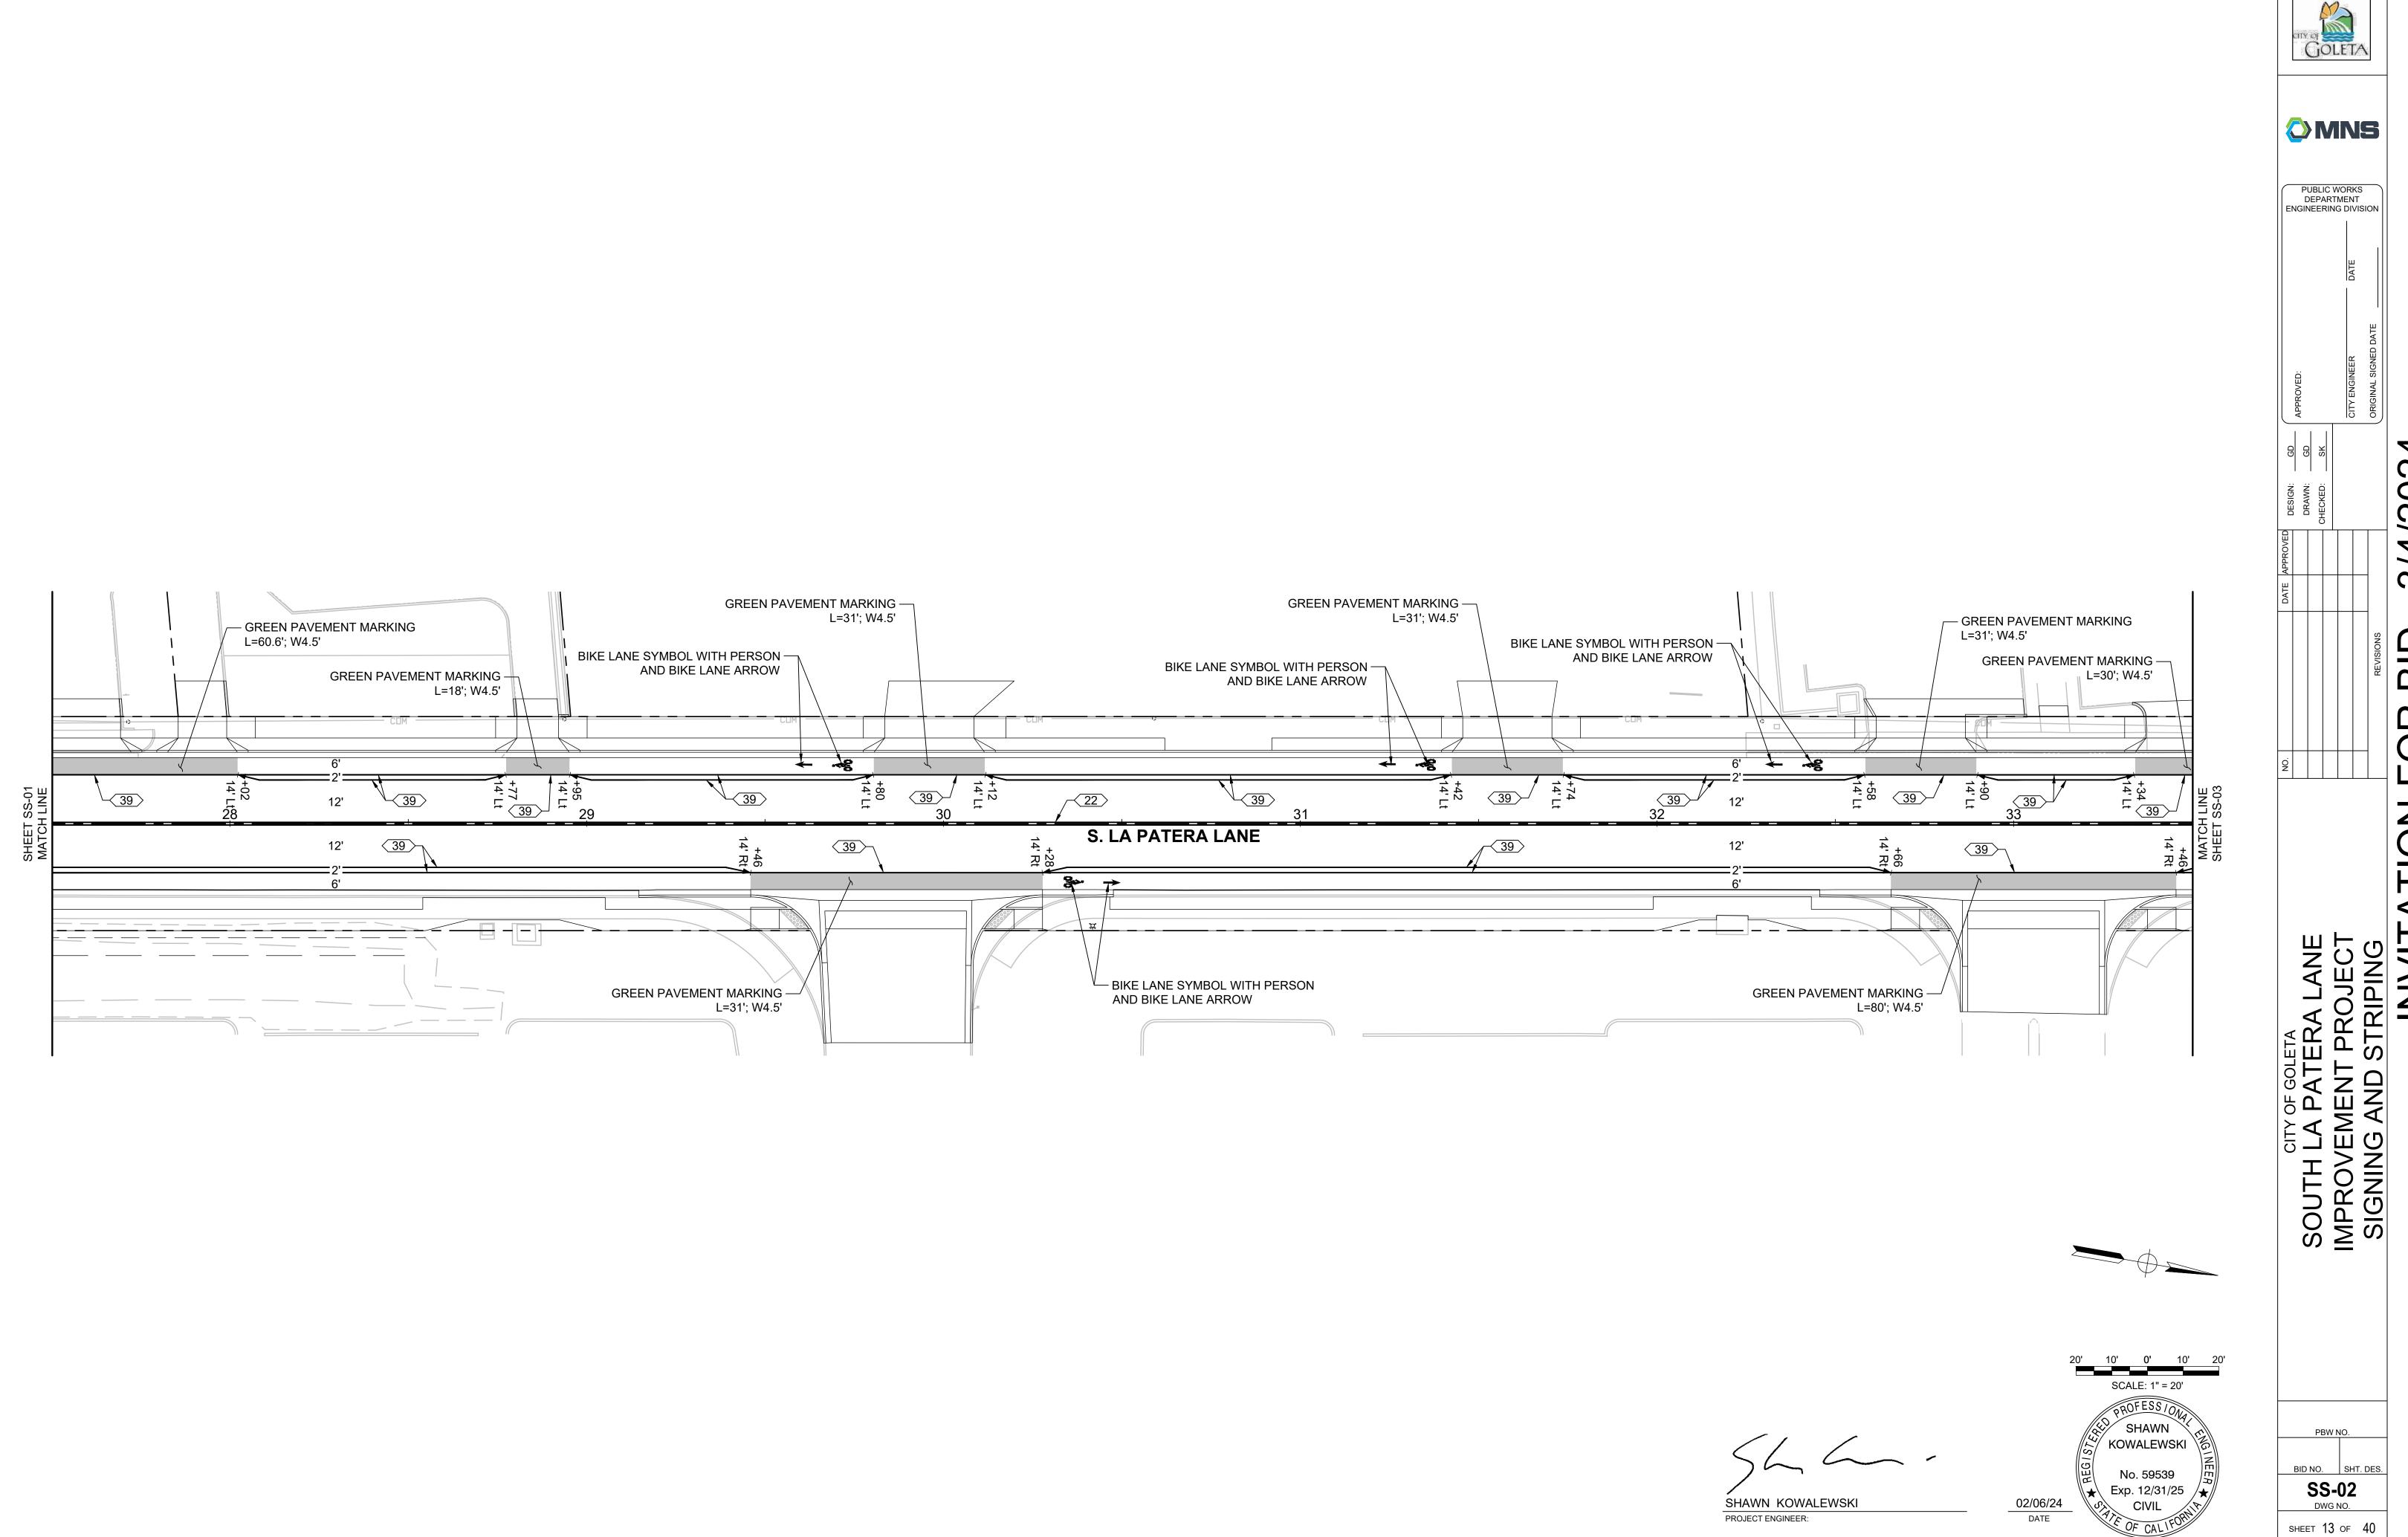

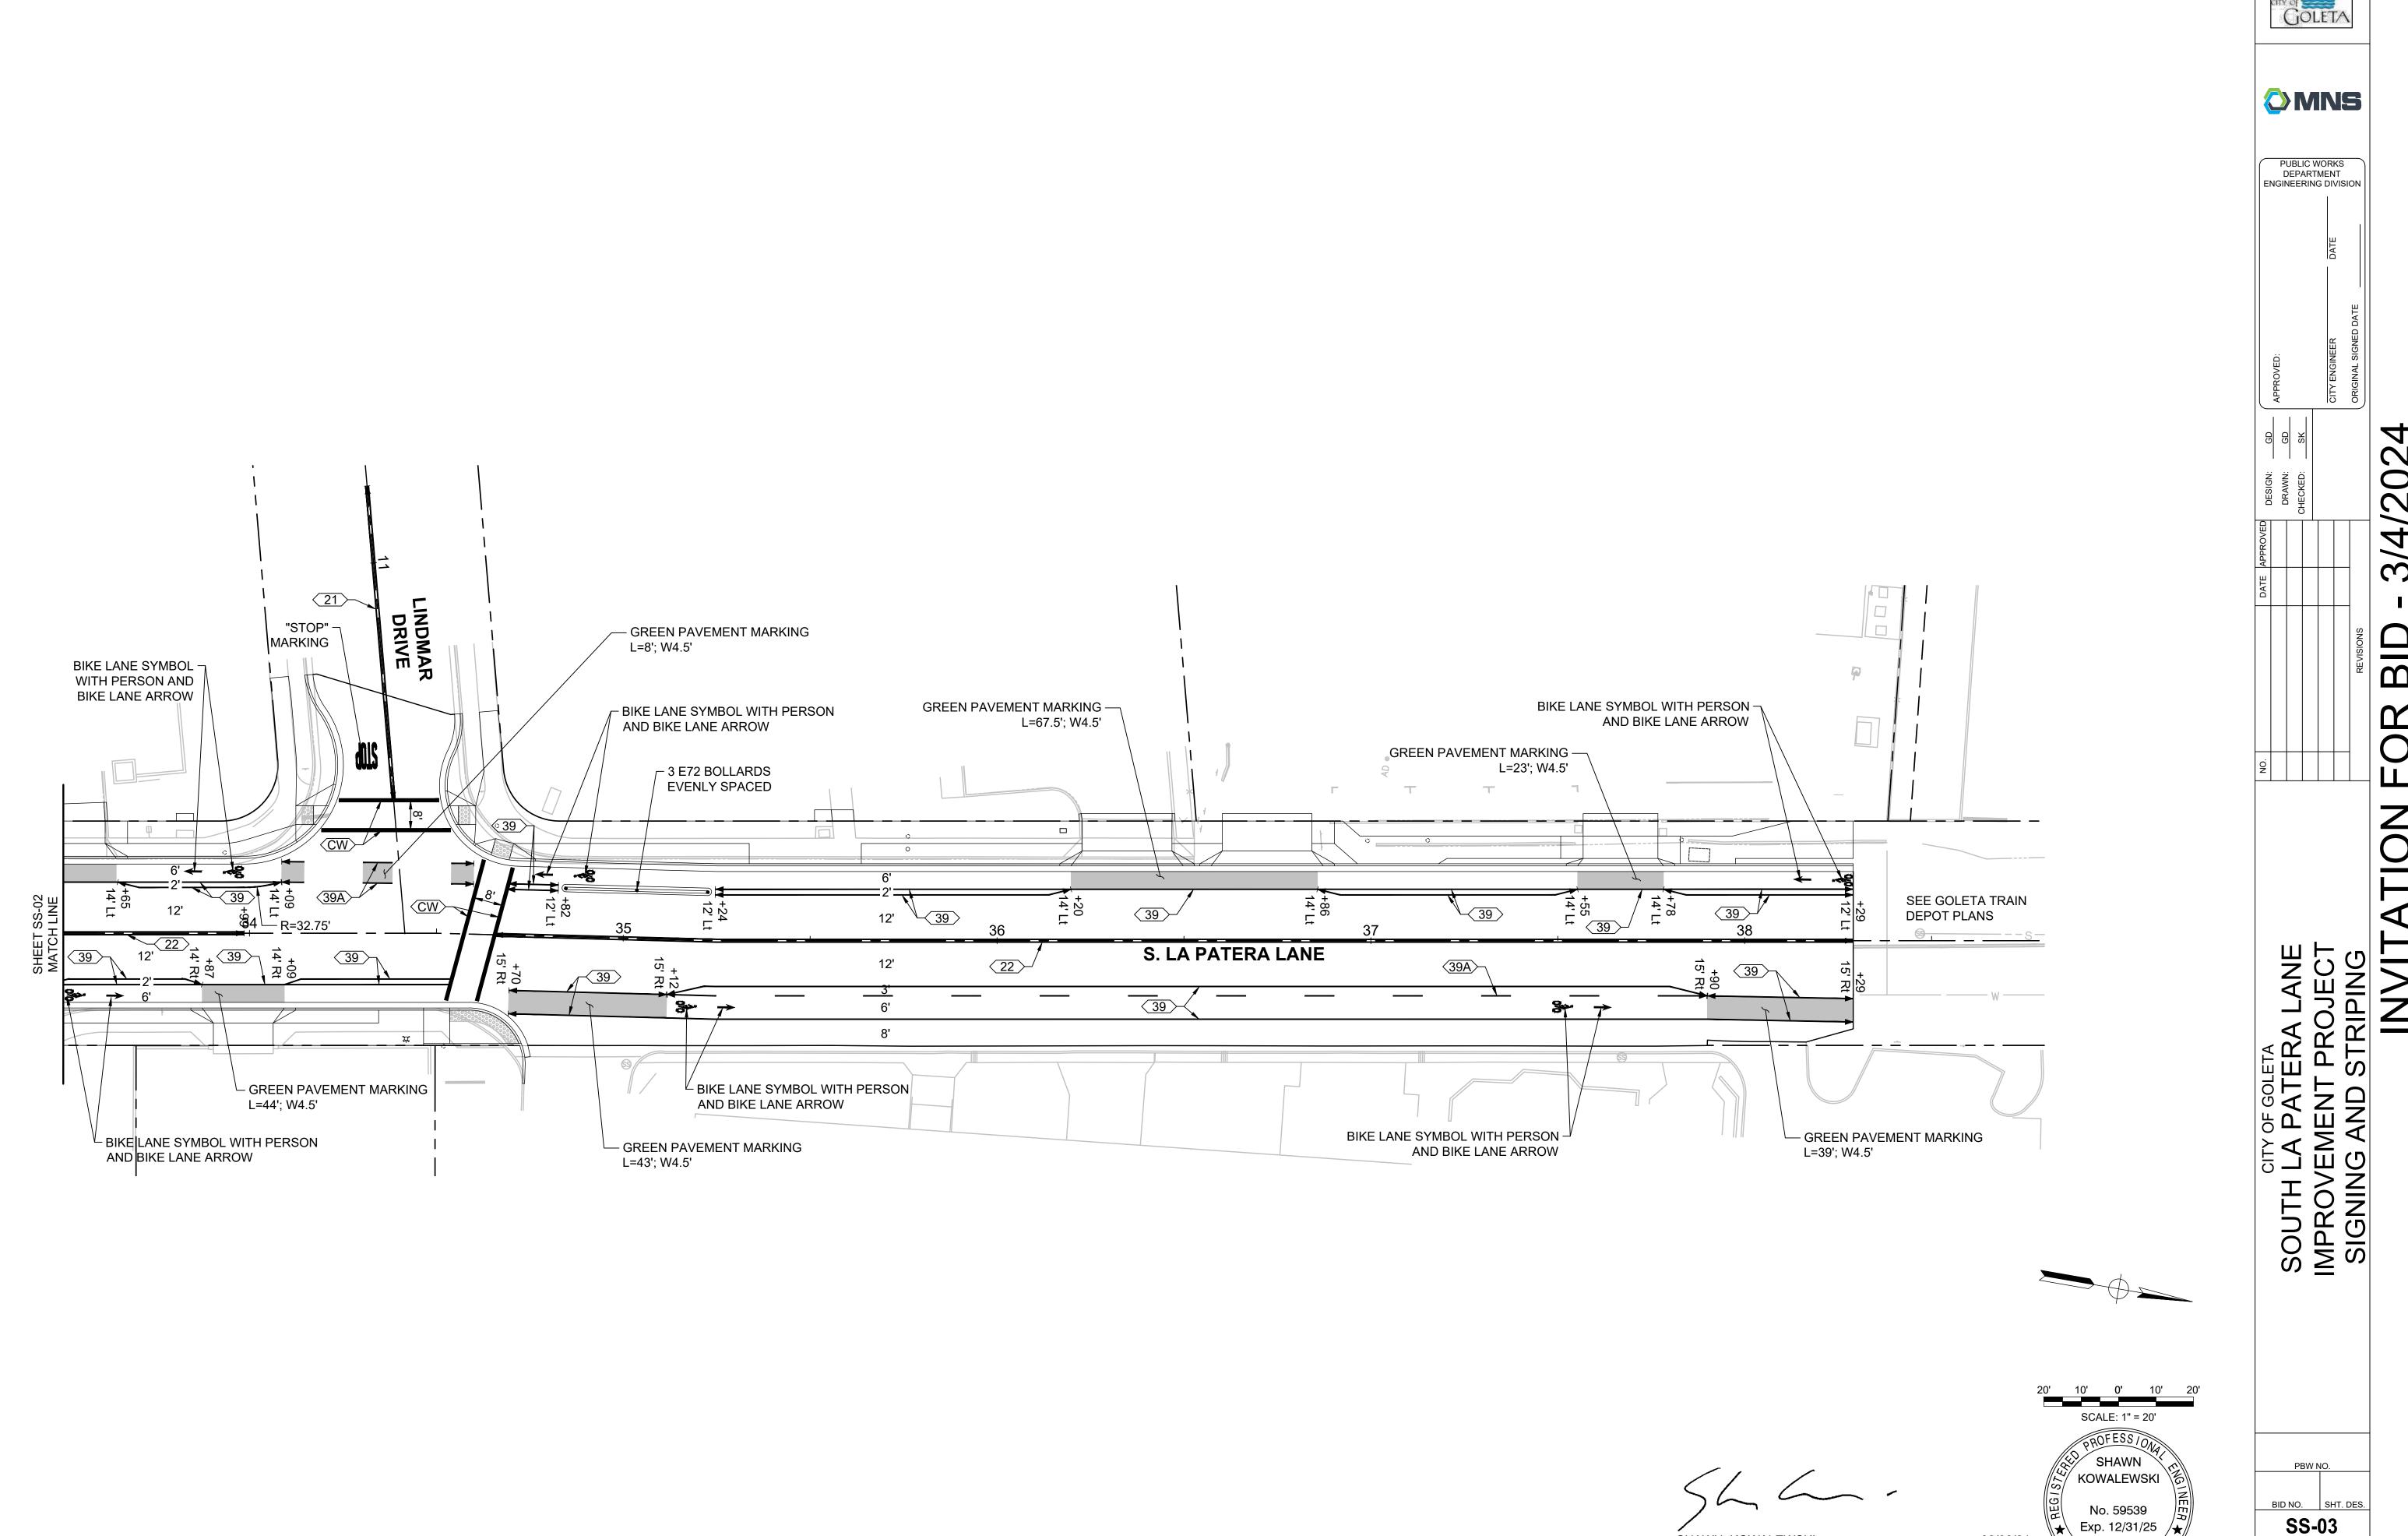


SS-03 DWG NO. SHEET 14 OF 40

02/06/24 DATE

SHAWN KOWALEWSKI

PROJECT ENGINEER:

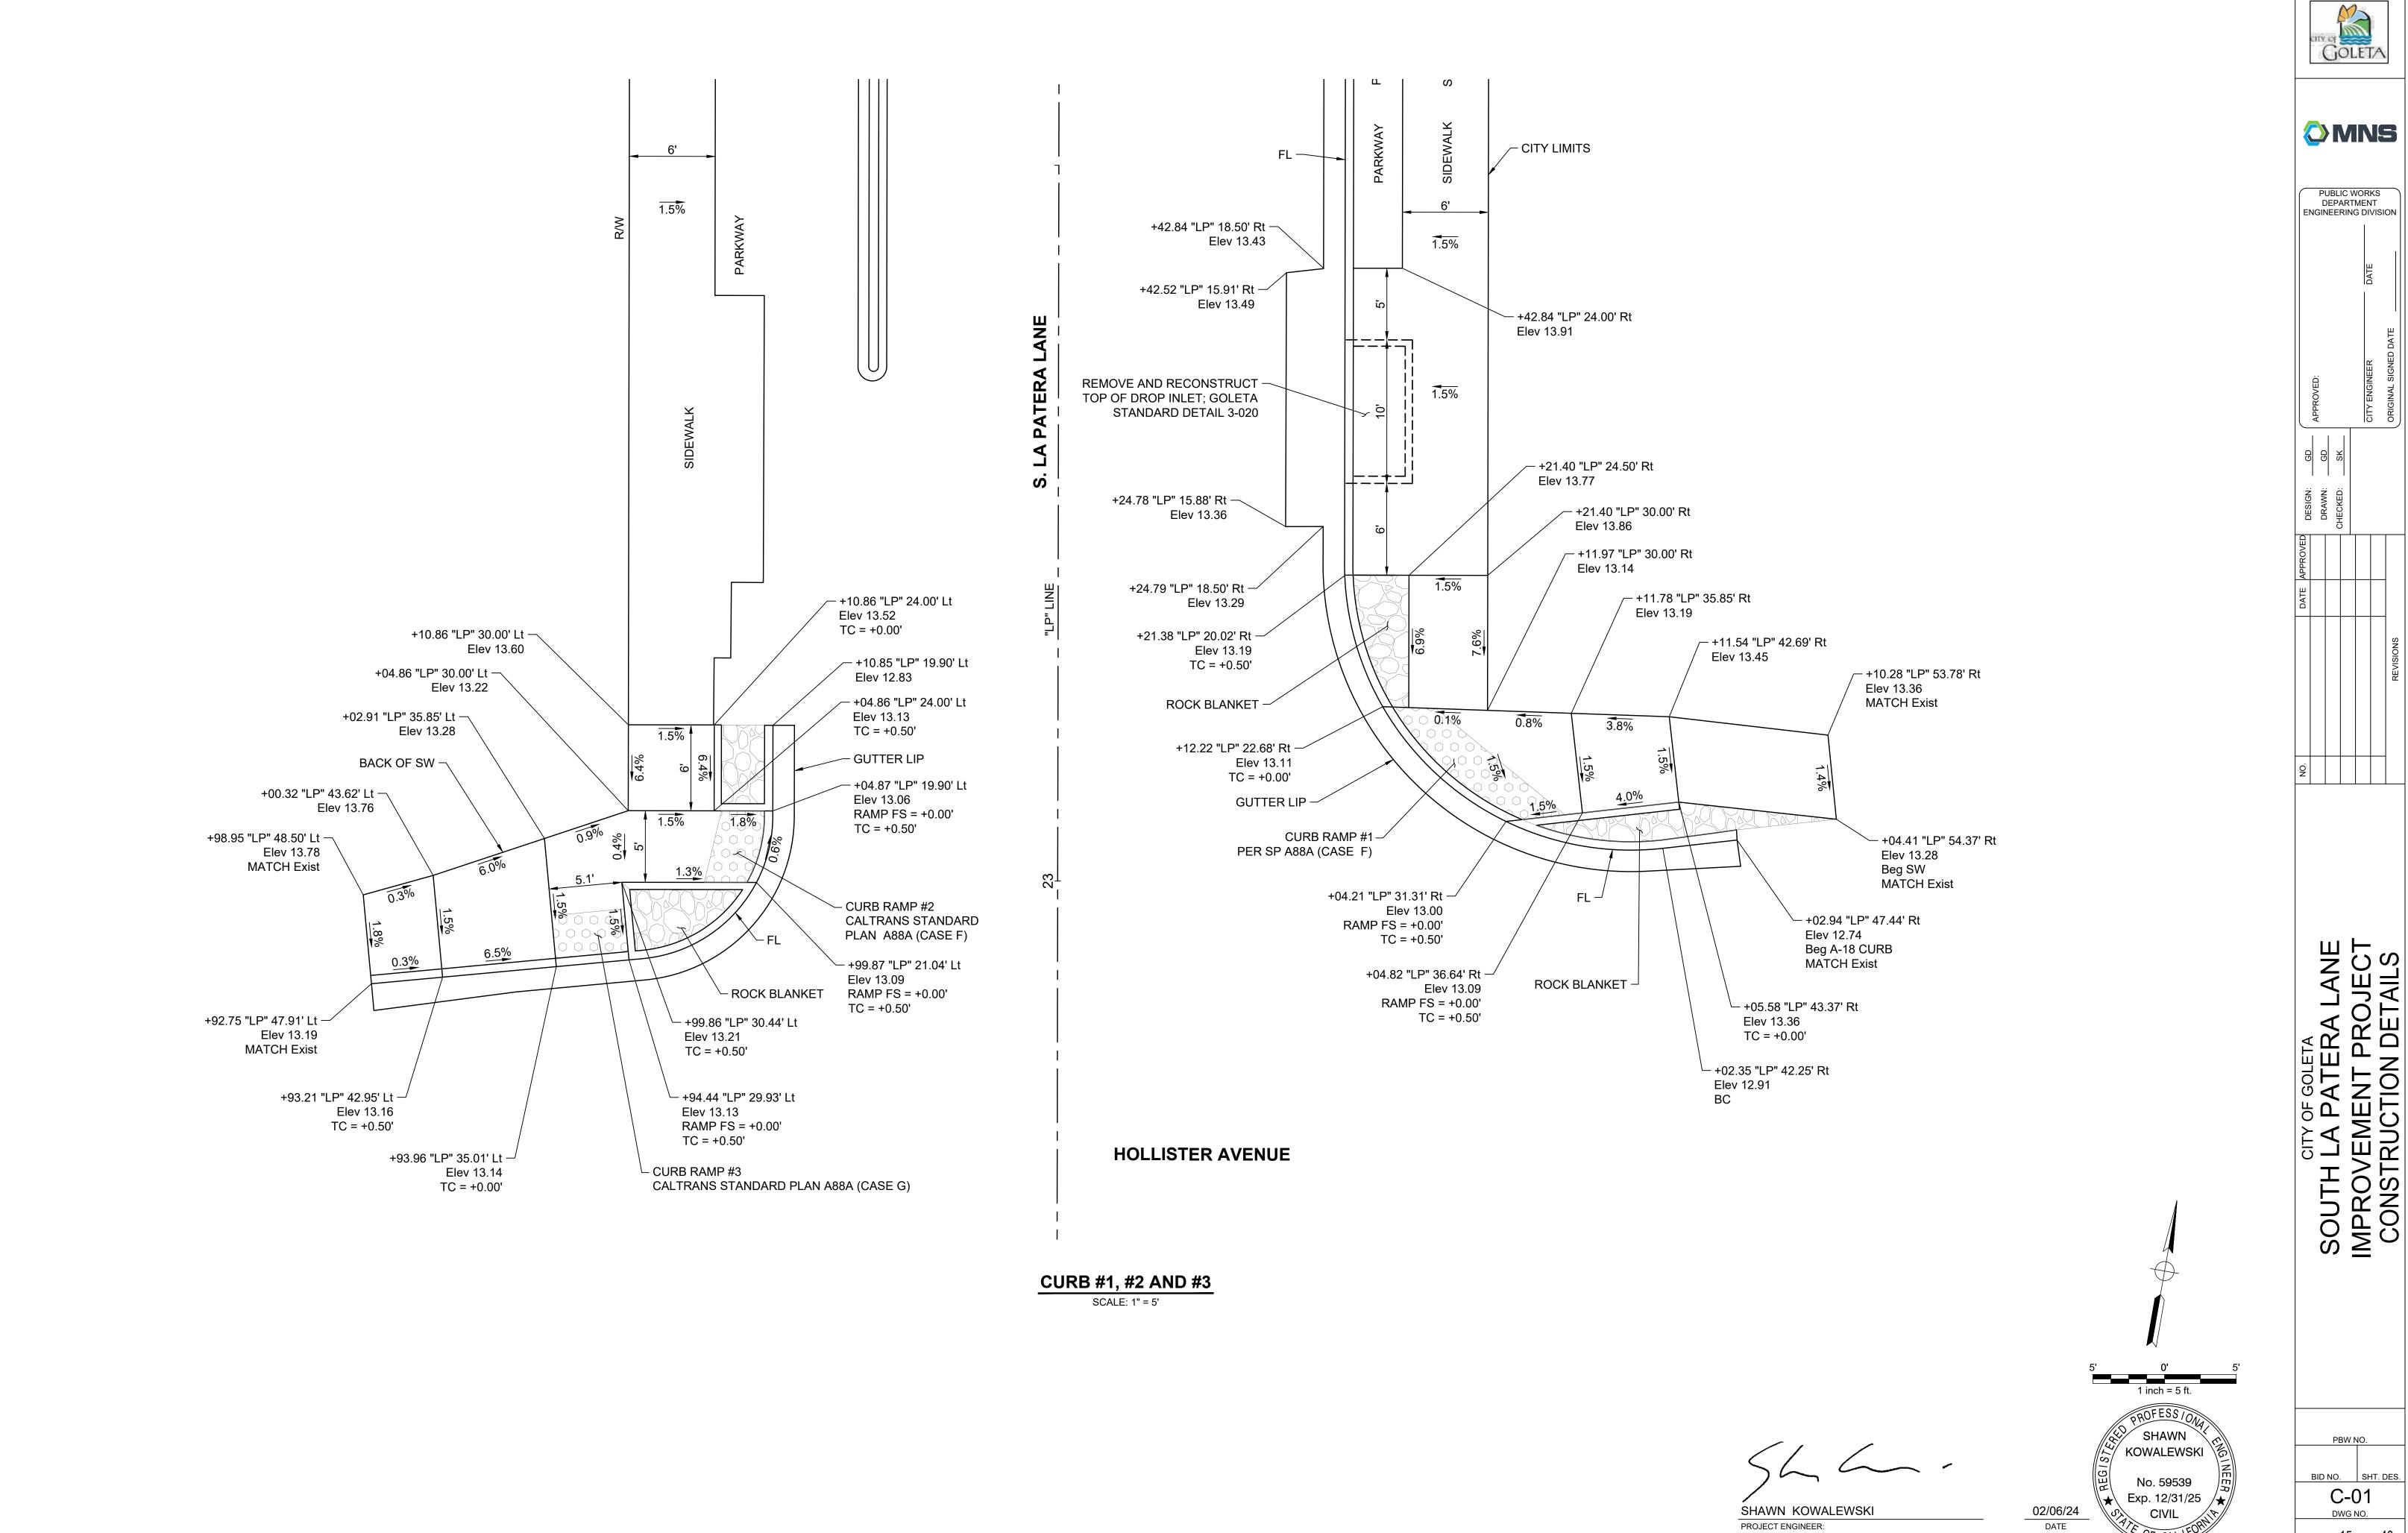

BID NO. SHT. DES. C-01 SHEET 15 OF 40

SHEET 16 OF 40


PBW NO.

BID NO. SHT. DES

C-03


DWG NO.

SHEET 17 OF 40

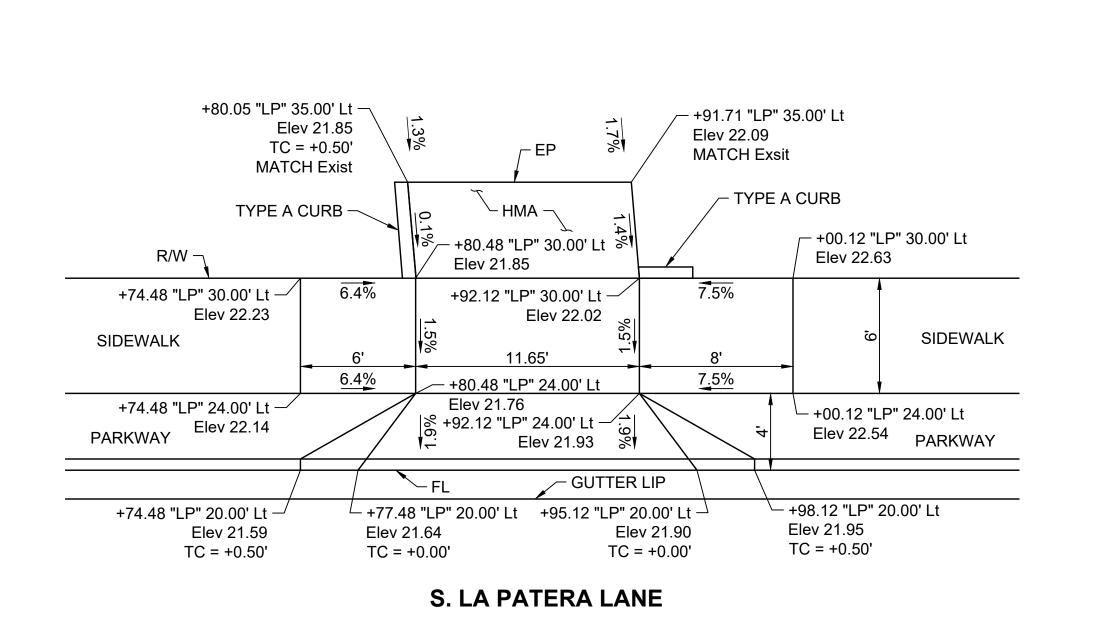


DRIVEWAY #6

SCALE: 1" = 5'

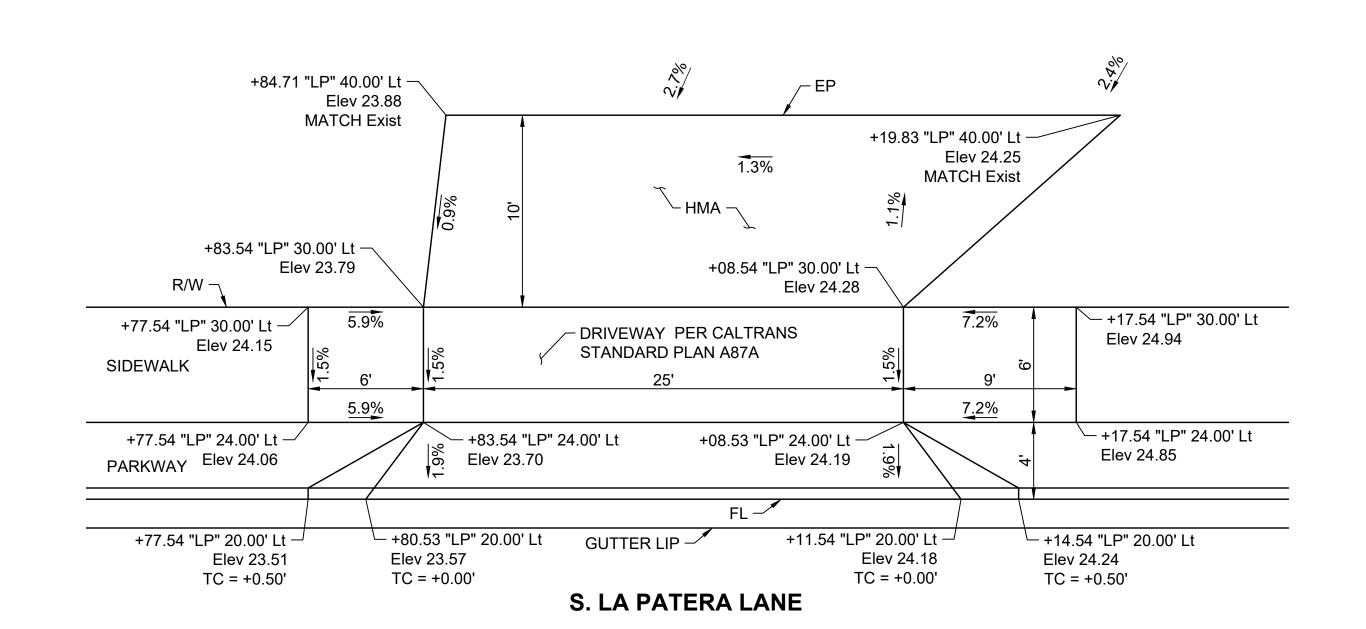

DRIVEWAY #8 SCALE: 1" = 5'

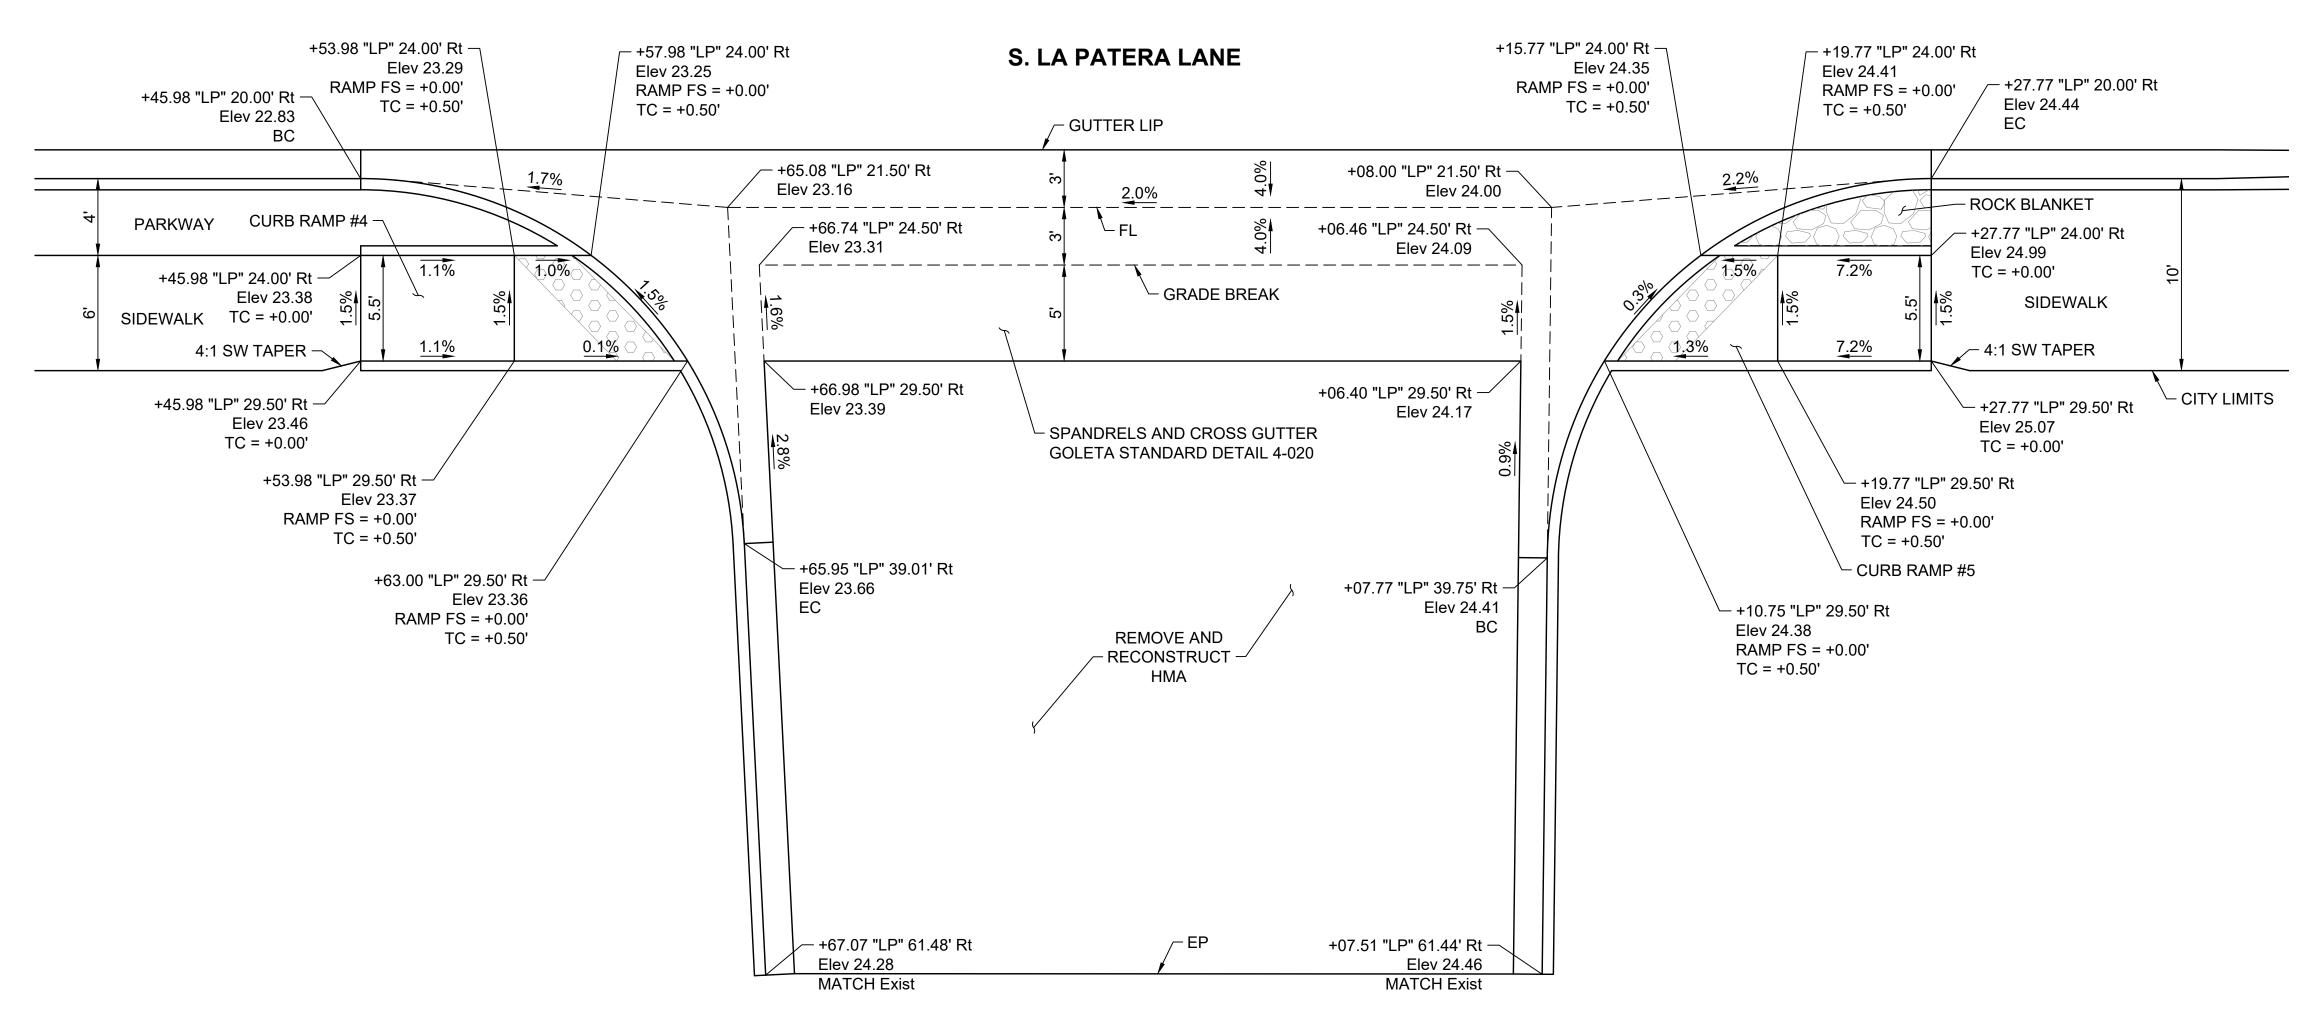


DRIVEWAY #7 AND CURB RAMP #4 & #5 SCALE: 1" = 5'

1 inch = 5 ft. SHAWN KOWALEWSKI No. 59539 Exp. 12/31/25 02/06/24 SHAWN KOWALEWSKI DATE

PROJECT ENGINEER:

3/4/20 BD

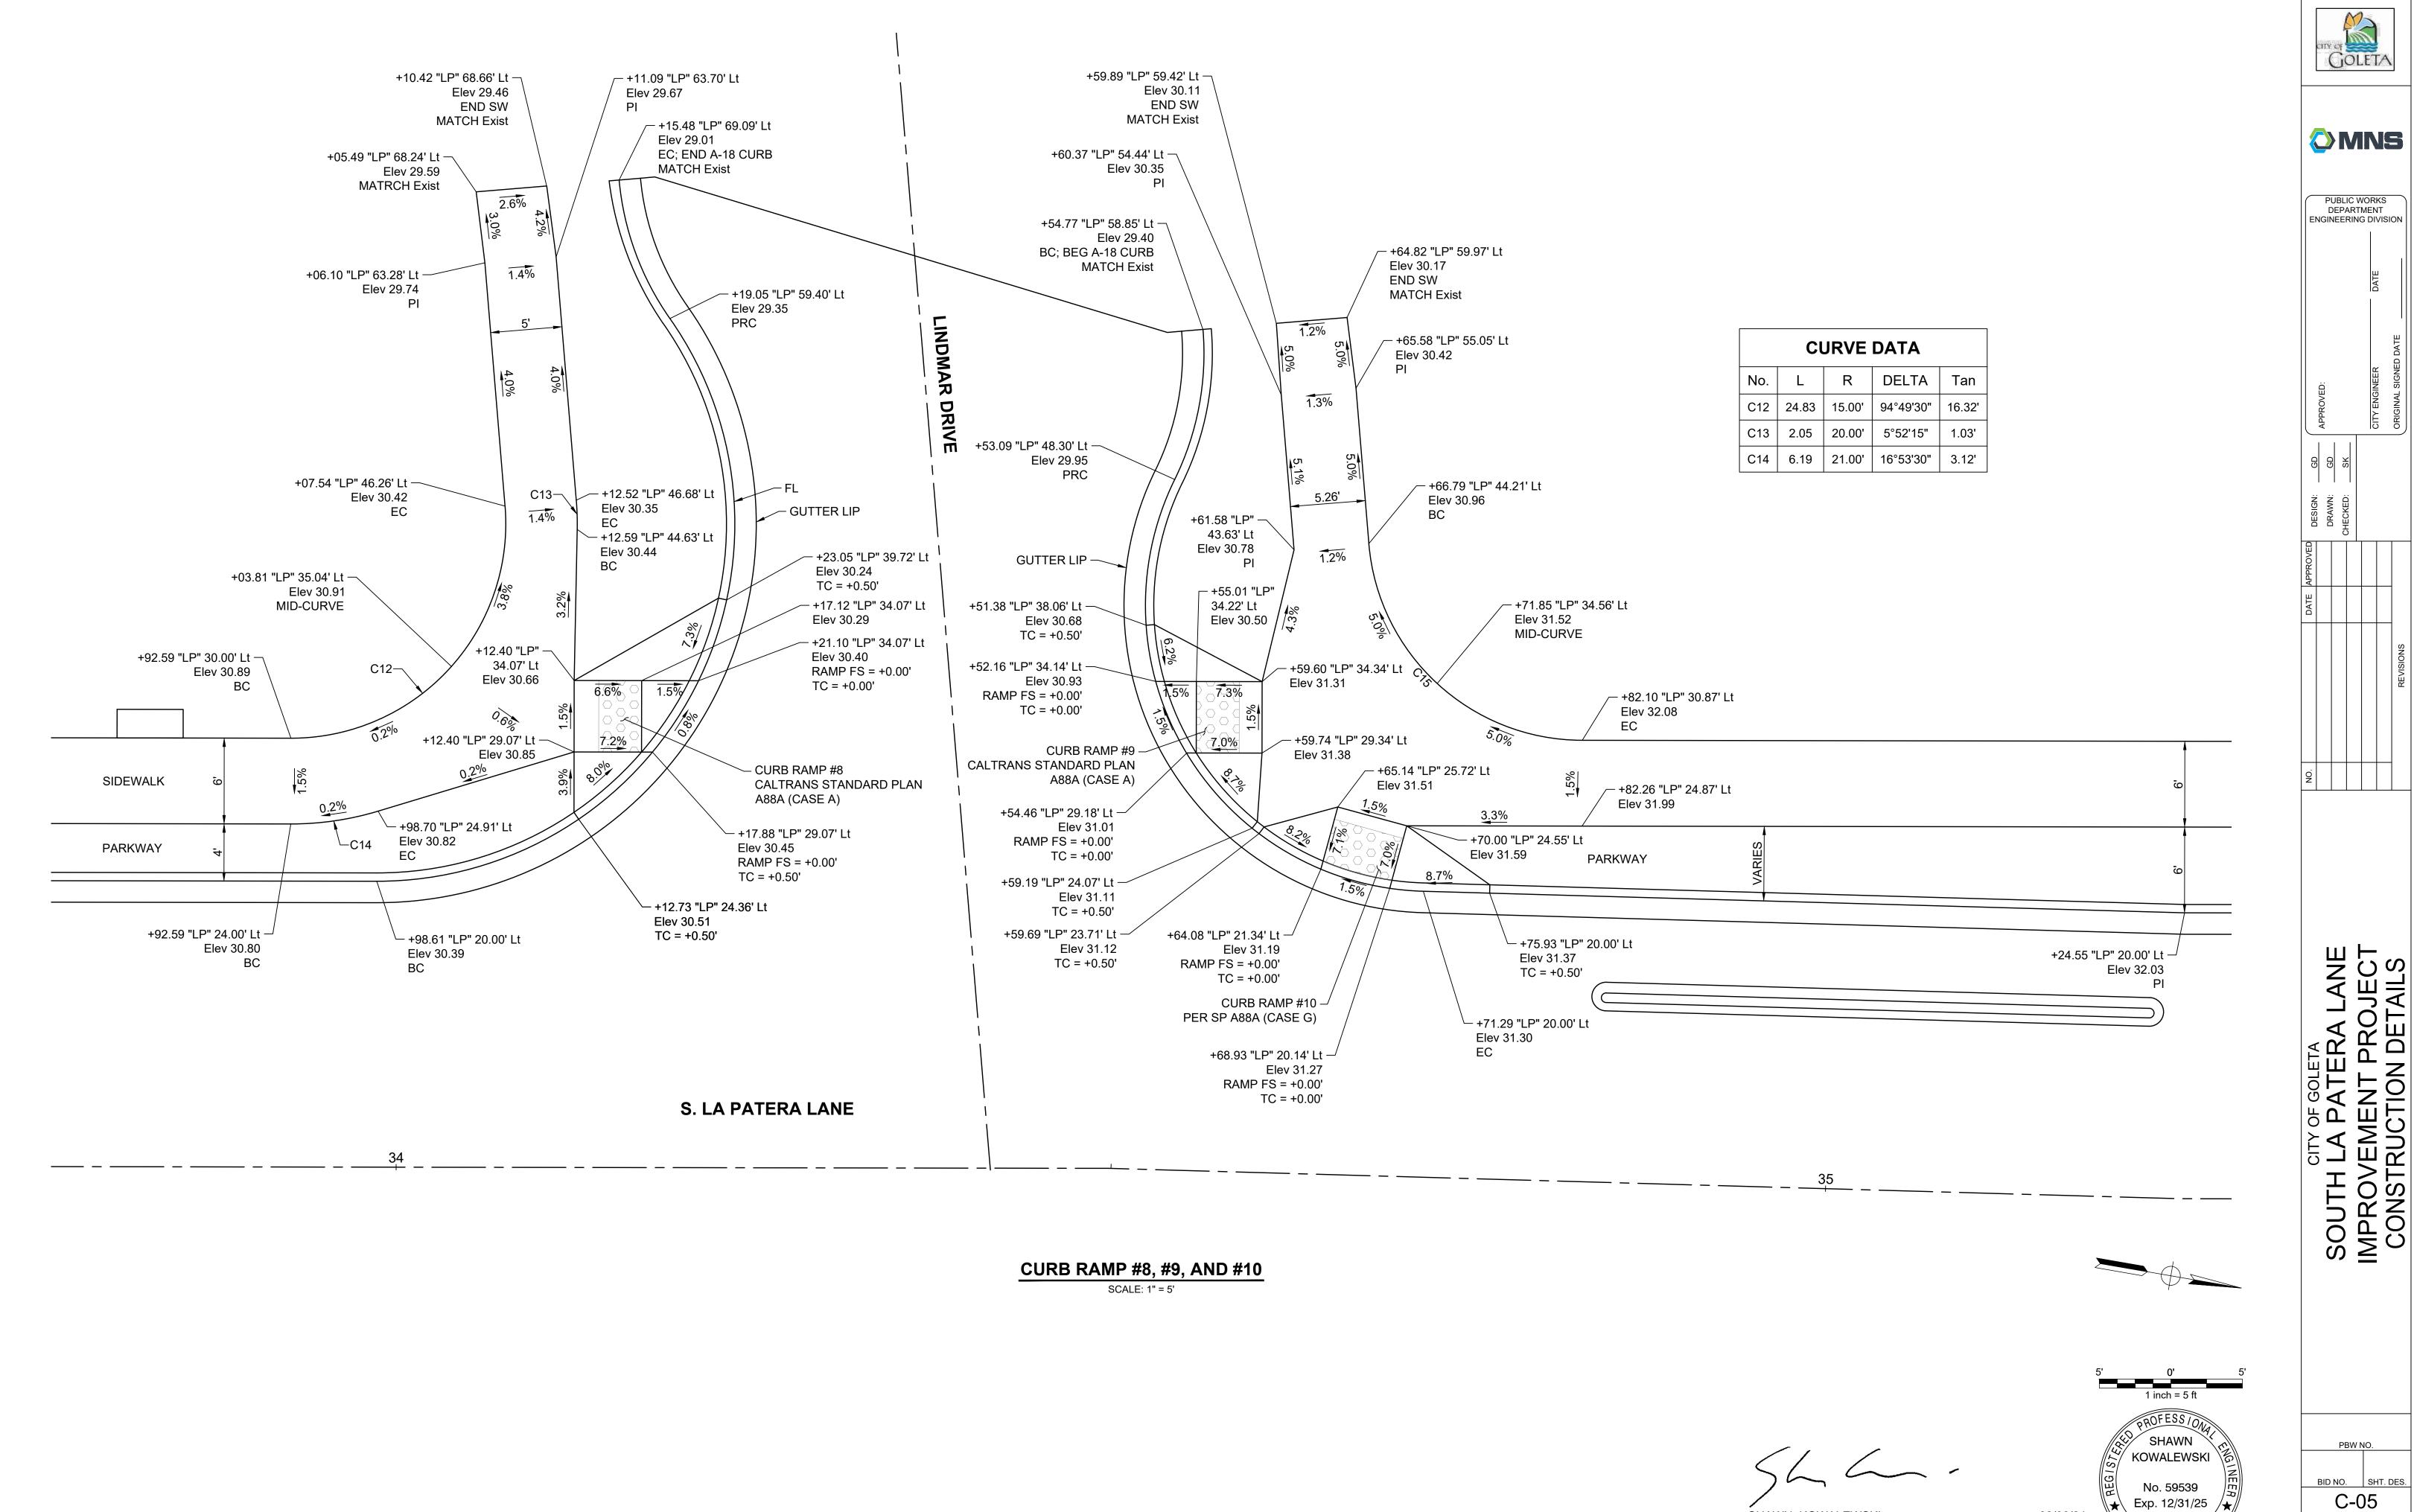

BD

C-05 DWG NO. SHEET 19 OF 40

02/06/24 DATE

SHAWN KOWALEWSKI

PROJECT ENGINEER:

BID NO. SHT. DES.

C-06

DWG NO.

SHEET 20 OF 40

1 inch = 5 ft. SHAWN KOWALEWSKI 答 No. 59539 **★** Exp. 12/31/25 **★**

02/06/24 DATE

SHAWN KOWALEWSKI

PROJECT ENGINEER:

TC = +0.00'Elev 30.10 Elev 30.47 TC = +0.50'TC = +0.50'_ +59.27 "LP" 19.76' Rt +46.56 "LP" 20.00' Rt — **GUTTER LIP** Elev 30.78 - +87.33 "LP" 20.00' Rt +09.32 "LP" 20.00' Rt ¬ Elev 30.74 Elev 30.14 Elev 30.44 CURB RAMP #11 TC = +0.50'TC = +0.00" TC = +0.00" TC = +0.00'CALTRANS STANDARD PLAN A88B (CASE CM) PARKWAY PARKWAY - +73.48 "LP" 28.88' Rt Elev 30.88 - +90.33 "LP" 24.00' Rt -- +06.32 "LP" 24.00' Rt RAMP FS = +0.00Elev 30.73 TC = +0.50'Elev 30.95 SIDEWALK 6.8% 0.1% CONTOUR GUTTER PAN TO ACCEPT FLOW FROM CROSS GUTTER +34.54 "LP" 24.00' Rt — Elev 31.19 END PARKWAY Beg WIDE SW -+90.33 "LP" 30.00' Rt -+06.32 "LP" 30.00' Rt -- +74.51 "LP" 32.56' Rt Elev 30.82 MATCH Exist Elev 31.04 Elev 31.04 END A-18 CURB Beg TYPE A CURB MATCH Exist +46.59 "LP" 29.50' Rt — +54.35 "LP" 29.39' Rt Elev 30.90 RAMP FS = +0.00 TC = +0.50' Elev 31.38 TC = 0.00' - +74.67 "LP" 34.81' Rt Elev 31.17 EC - +74.66 "LP" 39.56' Rt Elev 31.23 END TYPE A CURB MATCH Exist

S. LA PATERA LANE

- +84.33 "LP" 20.00' Rt

+12.32 "LP" 20.00' Rt -

_ +54.10 "LP" 19.89' Rt

Elev 30.76

DRIVEWAY #13 AND CURB RAMP #11

SCALE: 1" = 5'


SOUTH LA PATERIMPROVEMENT P

BID NO. SHT. DES


C-07


DWG NO.


SHEET 21 OF 40

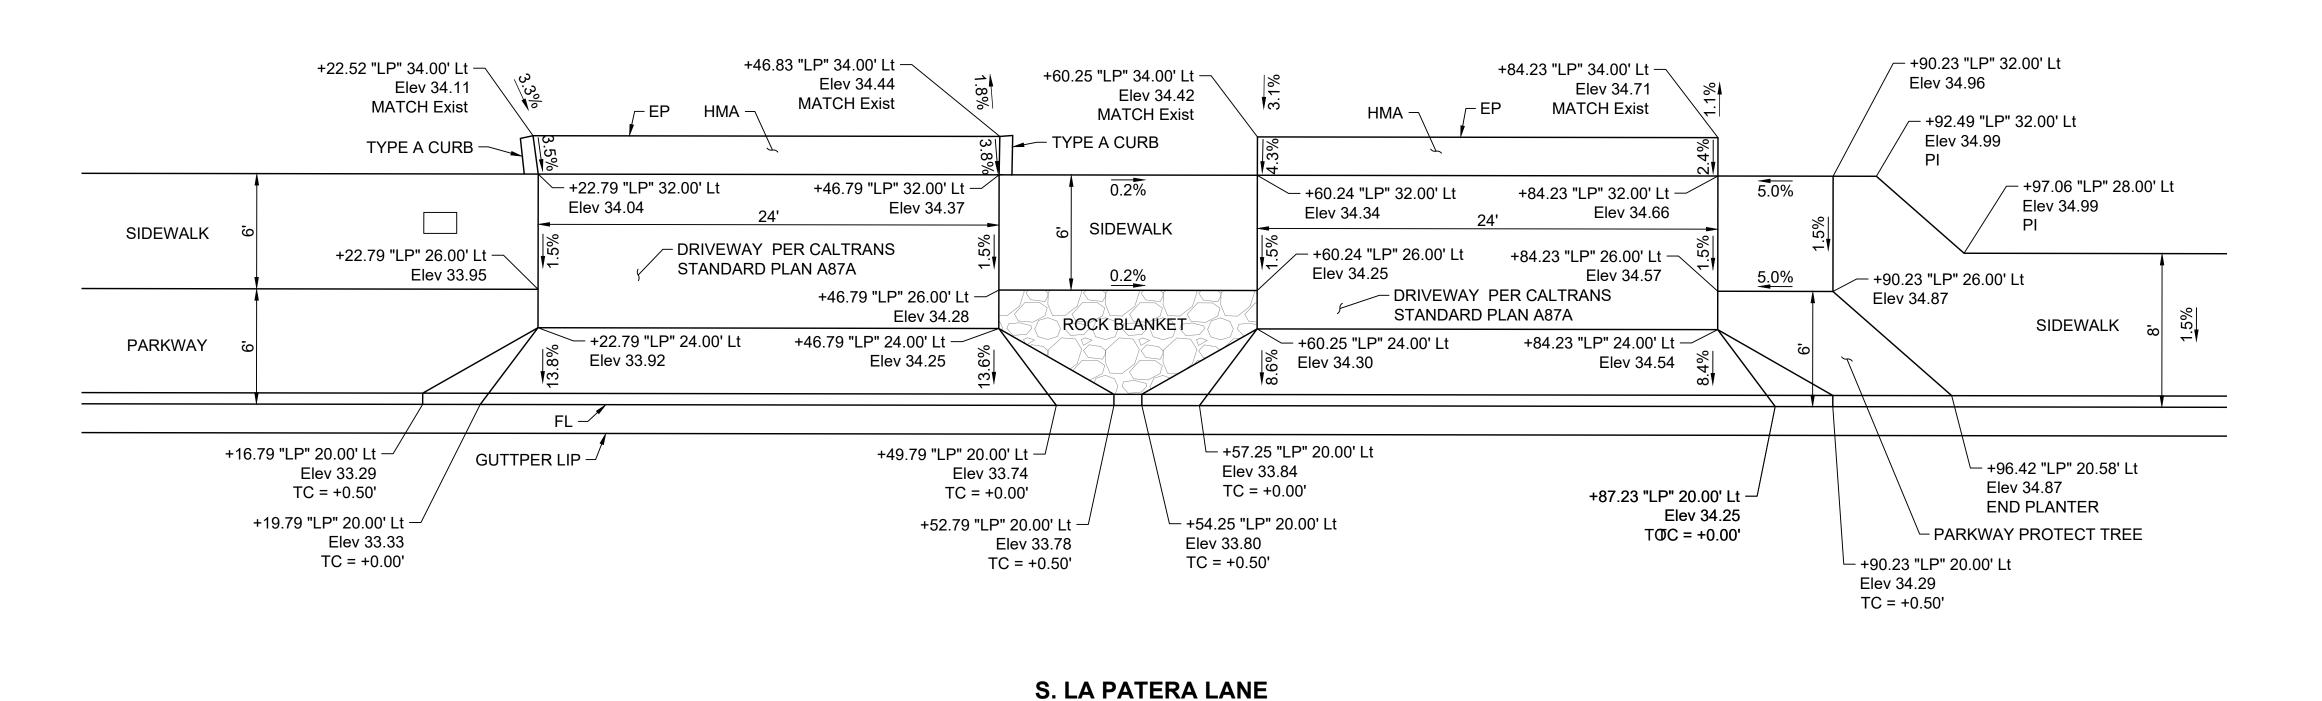

DRIVEWAY #14 AND #15 SCALE: 1" = 5'

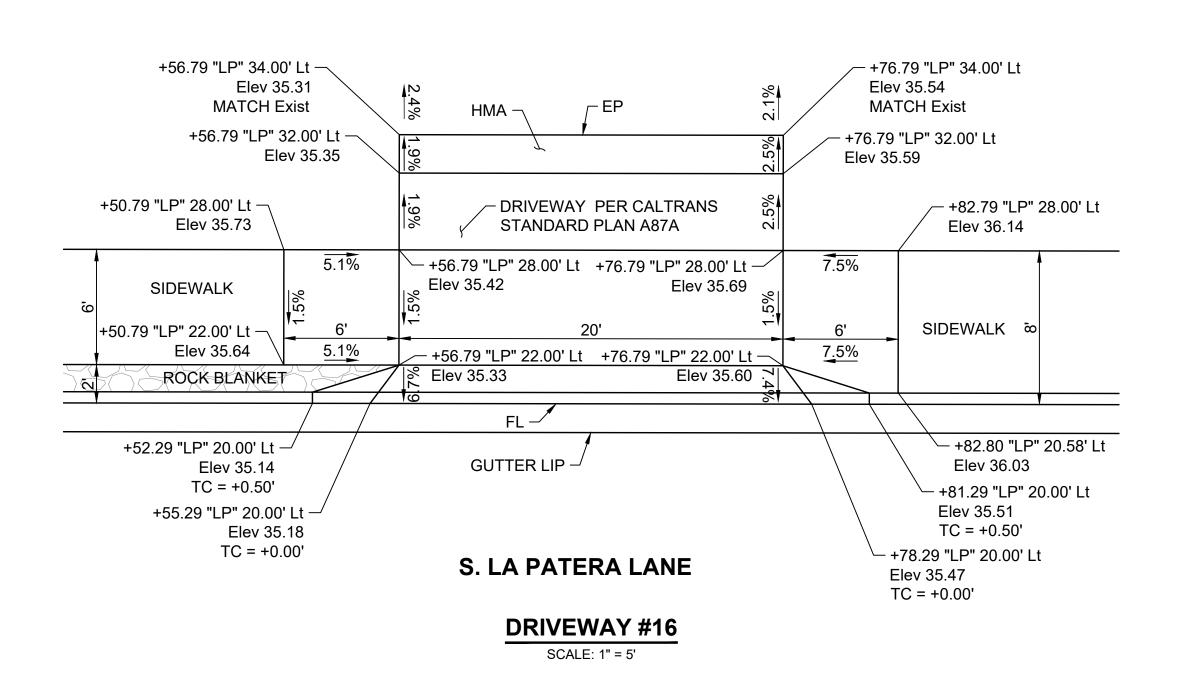


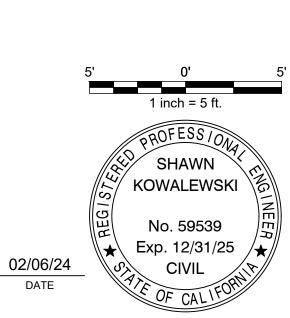

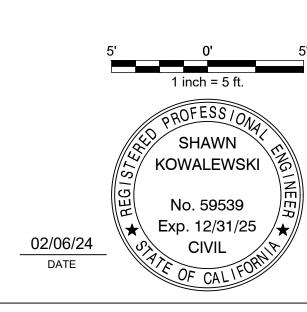

SHAWN KOWALEWSKI

PROJECT ENGINEER:

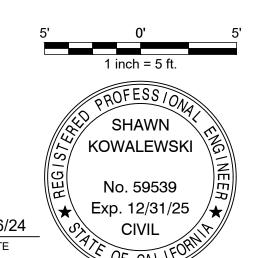


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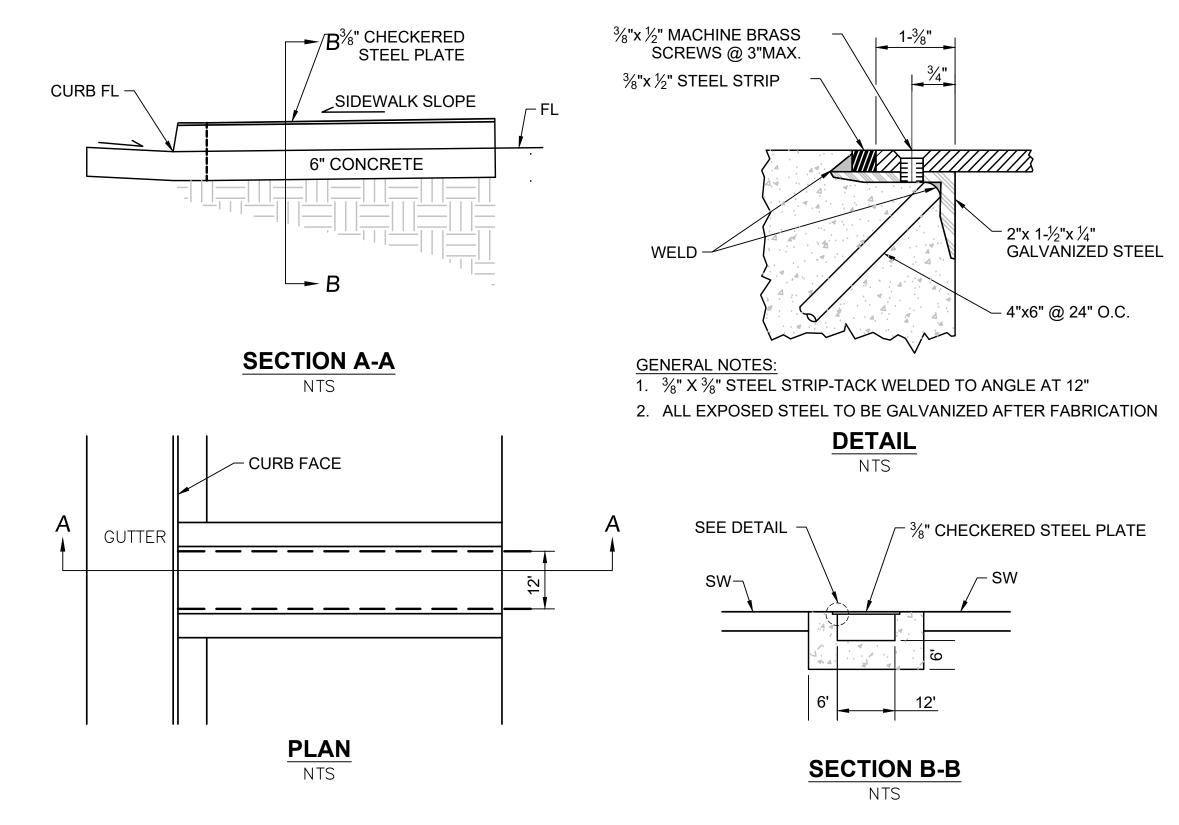
DWG NO.

SHEET 22 OF 40


PUBLIC WORKS
DEPARTMENT
ENGINEERING DIVISION

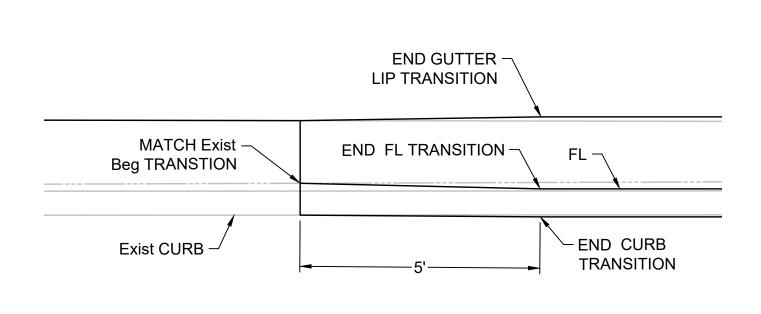



A-18 CURB TRANSITION DETAIL EXIST TO NEW SCALE: 1" = 2'




SIDEWALK UNDERDRAIN

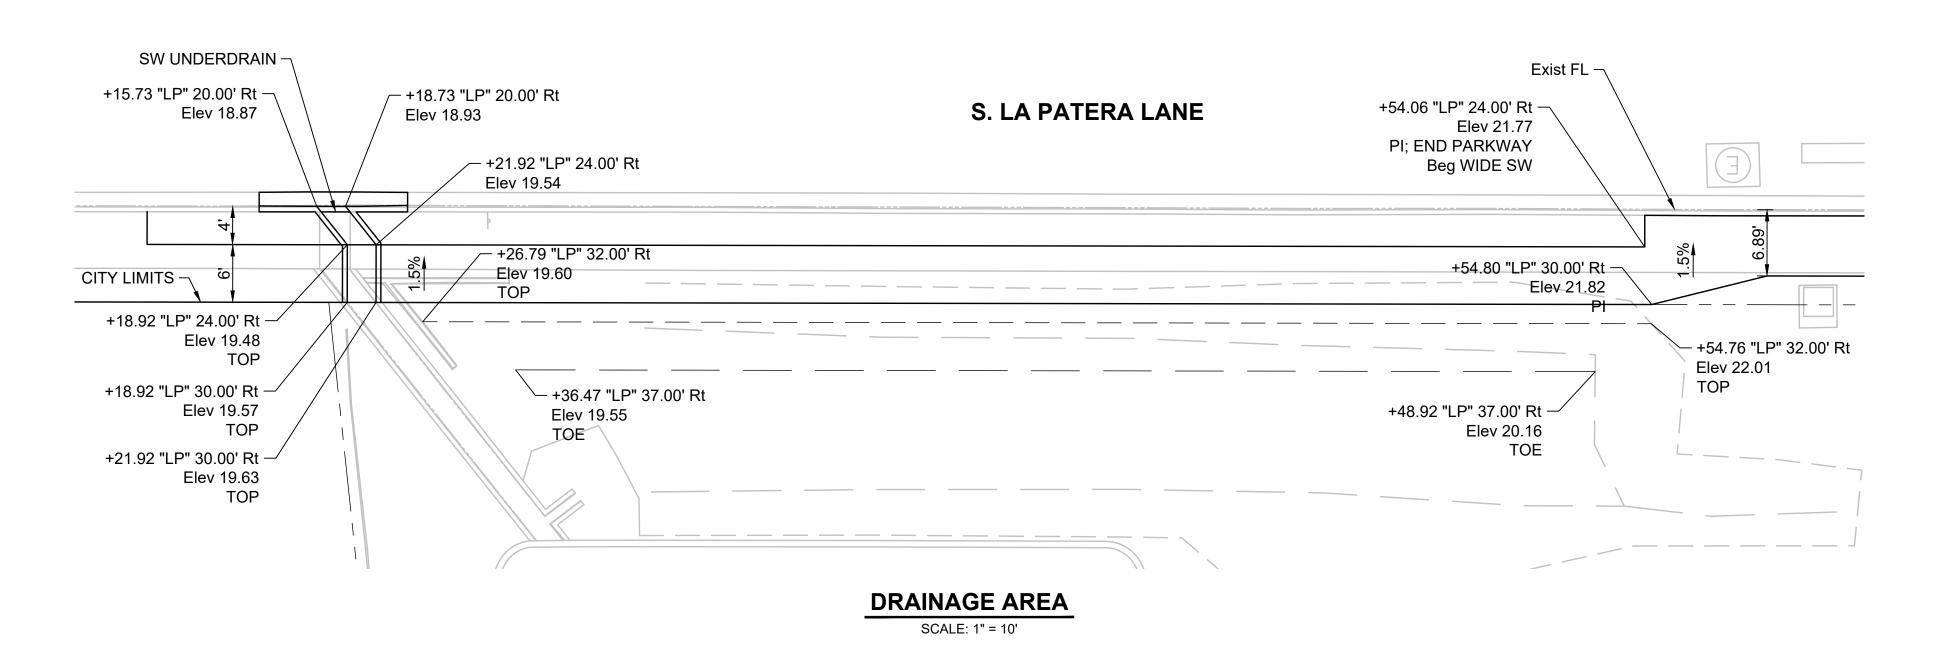

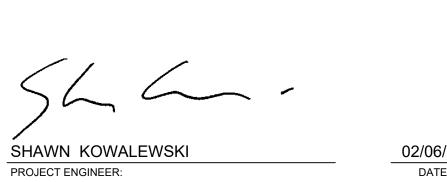


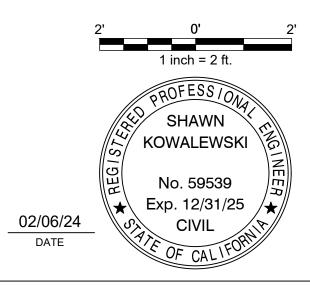



BID NO. SHT. DES. C-09 DWG NO. SHEET 23 OF 40

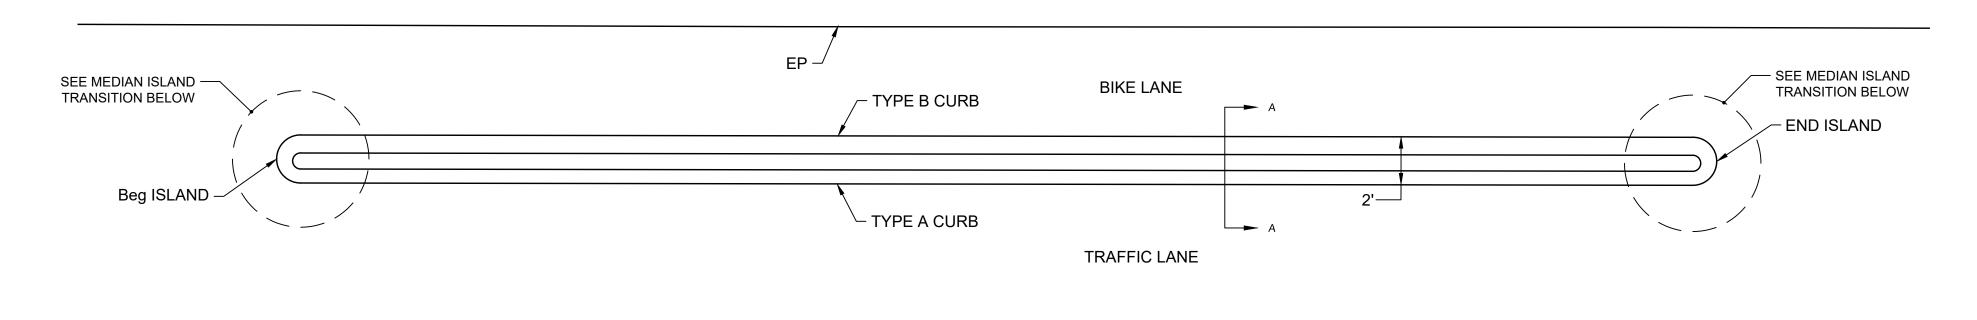


MEDIAN ISLAND SCALE: 1" = 4'

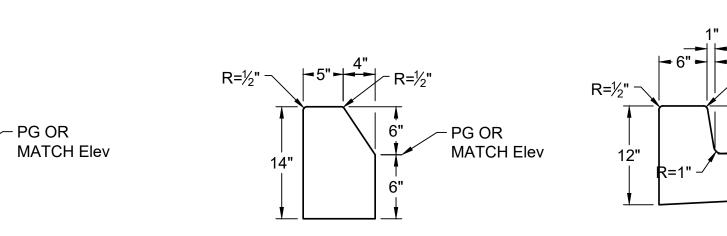

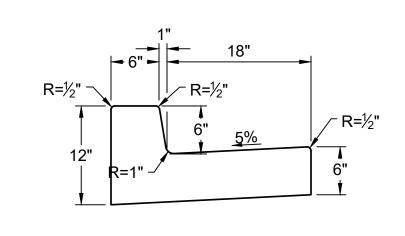

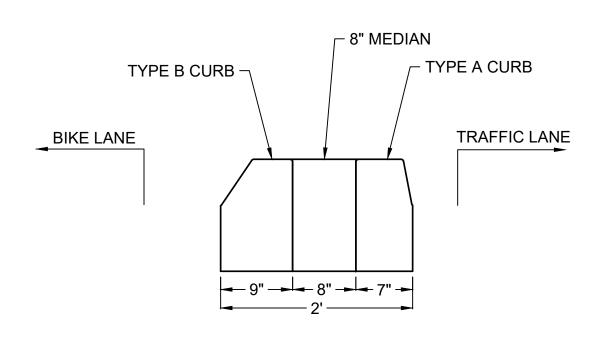

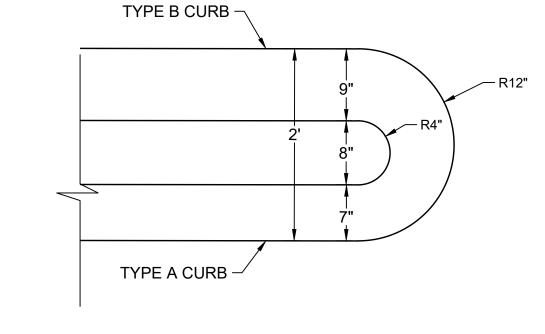

MEDIAN ISLAND TRANSITION

SCALE: 1" = 1'

TYPE A CURB SCALE: 1" = 1'

TYPE B CURB SCALE: 1" = 1'


A-18 CURB

SCALE: 1" = 1'

MEDIAN ISLAND SECTION

SCALE: 1" = 1'


SHAWN KOWALEWSKI PROJECT ENGINEER:

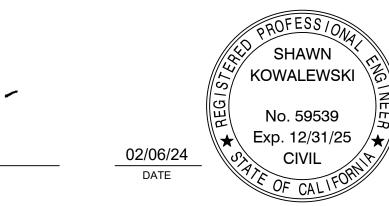

COORDINATION AND REFERENCE NOTES

SYMBOL	REFERENCE	DESCRIPTION
1	PROPERTY LINE	PER CIVIL ENGINEER'S DWGS
2	EXISTING SIDEWALK	EXISTING TO REMAIN PER CIVIL ENGINEER'S DWGS
3	EXISTING CURB	PROTECT IN PLACE
4	EXISTING TREE, TYP.	PROTECT IN PLACE. SEE L801 FOR TREE PROTECTION NOTES
(5)	CURB RAMP	PER CIVIL ENGINEER'S DWGS
6	LIGHT POLE	PER ELECTRICAL ENGINEER'S DWGS
7	UTILITY	PER CIVIL AND MECHANICAL ENGINEER'S DWGS
8	DRAINAGE	PER CIVIL ENGINEER'S DWGS
9	DRAIN GRATE	PER MECHANICAL ENGINEER'S DWGS (PROVIDE BRASS GRATE)
10	PROPOSED SIDEWALK	PER CIVIL ENGINEER'S DWGS
11)	RETAINING WALL	PER CIVIL ENGINEER'S DWGS
12	EXISTING TREE (REMOVED)	PER CIVIL ENGINEER'S DWGS
13	BUFFERED BIKE LANE	PER CIVIL ENGINEER'S DWGS
14)	ELECTRICAL METER PEDESTAL	PER ELECTRICAL ENGINEER'S DWGS

SYMBOL LEGEND

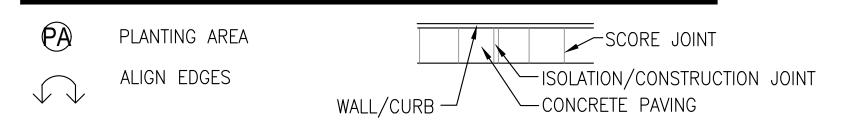

MANUFACTURERS AND SUPPLIERS

<u>PAVING</u>

- 1. INTEGRAL COLOR CONCRETE DAVIS COLORS: (800) 356-4848
- 2. TOP-CAST GRACE CONSTRUCTION PRODUCTS: (888) 336-9303
- 3. SOUTHWEST BOULDER AND STONE: (714) 882-1010 OR APPROVED EQUIVALENT

MATERIAL SCHEDULE REFERENCES

P1 PAVING NOTE - REFER TO 'PAVING SCHEDULE'

C1 CURB NOTE - REFER TO 'CURB SCHEDULE'

MISCELLANEOUS MATERIALS SCHEDULE

•	SYMBOL	DETAIL	DESCRIPTION	COMMENTS	QUANTITY
	M1	1/ L601	METAL HEADER — ALUMINUM EDGING W/ STAKES		
	M2		BOULDER — SOUTHWEST NATURAL BOULDER. 20% AT 18"LX2'WX2'H, 30% AT 2'LX2'X2'H, 40% AT 30"LX30"WX30"H, 10% AT 30"LX42"WX30"H GRANITE BOULDER — ROUNDED FORM	BURY 1/3 OF AVERAGE THICKNESS BELOW GRADE.	

PAVING SCHEDULE

SYMBOL DETAIL	DESCRIPTION	PATTERN	COLOR	FINISH	JOINT	REINFORCEMENT	COMMENTS
P1 PER CIVIL 4/L601	CONCRETE PAVING	PER PLANS	NATURAL GRAY	MEDIUM BROOM	TOOLED W/ SHINER	PER CIVIL DWGS	SIDEWALK
P1V PER CIVIL 4/L601	VEHICULAR CONCRETE PAVING	PER PLANS	NATURAL GRAY	MEDIUM BROOM	TOOLED W/ SHINER	PER CIVIL DWGS	DRIVEWAYS
P2 1/ L601	SOUTHWEST BOULDER 50% - BAJA CREST - 6-12"	PER PLANS	BAJA CREST	N/A	N/A	N/A	IN PLANTERS
P3 1/ L601	SOUTHWEST BOULDER 50% — APACHE SUNSET — 1—3"	PER PLANS	APACHE SUNSET	N/A	N/A	N/A	IN PLANTERS
P4 1/3 L601	GAIL MATERIALS NATRACIL STABILIZED DECOMPOSED GRANITE	PER PLANS	GOLD	STABILIZED	N/A	N/A	PLANTER EDGES
P5 PER CIVIL	TACTILE PAVER	PER PLANS	YELLOW	TRUNCATED DOMES	N/A	N/A	AT ADA RAMPS

NOTES

PAVING NOTES

- 1. COORDINATE INSTALLATION OF SLEEVES, VAULT COVERS, ETC. W/ OTHER TRADES PRIOR TO POURING PAVING
- 2. VERIFY LAYOUT OF PAVING LIMITS WITH OWNER PRIOR TO BEGINNING WORK
- 3. CONTRACTOR SHALL MOCK-UP 4'x4' SAMPLES OF ALL PAVING ON SITE AT LOCATION DETERMINED BY OWNER TO SHOW FINISH, COLOR, JOINTING, & INTERSECTION OF PATTERNS AS REQUESTED BY OWNER. ALL SAMPLES SHALL BE APPROVED BY OWNER
- 4. MATCH PAVING WORK W/ CONTRACTOR'S OWNER APPROVED PAVING MOCK-UPS. WORK NOT MATCHING MAY
- 5. JOINTING & FINISHING TO MEET ADA REQ. FOR SLIP RESISTANCE & JOINT WIDTH (3/16" MAX.) 0.6 SLIP RESISTANCE COEFFICIENT
- 6. ALL WALKS, HEADERS, & WALLS SHALL HAVE SMOOTH, TANGENT, CONTINUOUS CURVES, UNLESS NOTED OTHERWISE
- 7. PAVING PATTERN TO BE CONTINUOUS BELOW ALL POTTERY AND FURNITURE (TYPICAL)
- 8. ALL PAVERS ARE TO SEALED WITH BP PRO/ VANN INC.

UTILITY NOTES:

- 1. BEFORE INSTALLING ALL UNDERGROUND FEATURES (i.e. FOOTINGS AND SERVICE LINES) VERIFY ALL LOCATIONS OF EXISTING UTILITIES AND COORDINATE WITH CIVIL, STRUCTURAL, ELECTRICAL, ARCH., AND MECH. DWGS OF THIS PACKAGE AND THE TRAIN DEPOT PACKAGE
- 2. CIVIL STRUCTURES (i.e. CATCH BASINS, MANHOLES, LIFT STATIONS) ARE SHOWN FOR COORDINATION ONLY
- 3. REFER TO CIVIL/MECH DWGS FOR GRADING/DRAINAGE STRUCTURES BEFORE INSTALLATION OF PAVING, FOOTINGS, ETC.


SOIL TESTING

- 1. SEE SPECIFICATIONS.
- 2. CONDUCT ON-SITE SOIL TESTS AT LOCATIONS SHOWN ON DRAWINGS WITH THIS SYMBOL:

 SOIL TEST
- 2) SAMPLE TAKEN FROM AN 18" SOIL DEPTH
- 3. FOR IMPORTED SOIL, CONDUCT 2 (TWO) TESTS PER

1) SAMPLE TAKEN FROM FINISH GRADE SURFACE



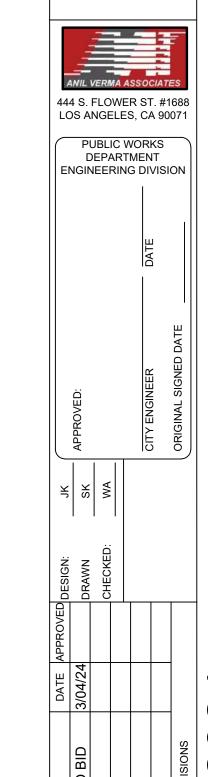

PATERA LANE IMPROVEMENT (FOR GOLETA TRAIN DEPOT) Hardscape Schedule

CIP-9079

BID NO. SHT. DES

L300

SHEET 24 OF 40


ANDSCAPE

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3/4/2024

3/4/2024

3/4/2024

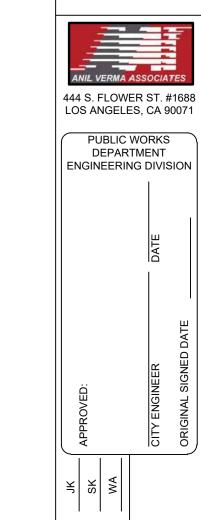

VEMENT DEPOT) SOUTH LA P PROJECT (F HARDSC/

CIP-9079

BID NO. SHT. DES L301 DWG NO.

SHEET 25 OF 40

DATE

MATERIAL SCHEDULE REFERENCE CALLOUTS

-PA

P2

P1

P# PAVING - REFER TO 'PAVING SCHEDULE'

L# LIGHT - REFER TO 'LIGHTING SCHEDULE'

SF# SITE FURNITURE - REFER TO 'SITE FURNITURE SCHEDULE'

HARDSCAPE FINISH PLAN

SCALE" 1" =20'-0"

P2 13

P2 PA

DECORATIVE
GRAVEL PLANTER
P2 P3

CONCRETE PAVING

GRANITE **P4**

M# MISCELLANEOUS MATERIAL — REFER TO 'MISCELLANEOUS MATERIALS SCHEDULE'

A. REFER TO L300 FOR GENERAL NOTES AND CONSTRUCTION SCHEDULE B. PROVIDE 18" SLIP DOWELS AT INTERFACE BETWEEN EXISTING PAVING

AND PROPOSED PAVING.

C. REFER TO CIVIL DRAWINGS FOR DEMOLITION AND GRADING

SYMBOL LEGEND PLANTING AREA ALIGN EDGES R/W RIGHT OF WAY

SCORE JOINT -CONCRETE PAVING -CONCRETE CURB

-ISOLATION / CONST. JOINT

STORM VAULT

P1

P3

P3

6-2-

S. LA PATERA LANE

P1V

P2

P4 P1

P3


NOTES

PROJECT ENGINEER: R.C.E. EXP.

TYP. M2

M2 TYP.

M1 TYP.

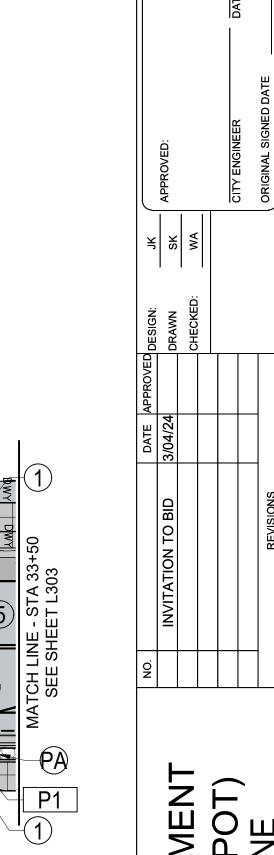

VEMENT DEPOT) SOUTH LA P PROJECT (F HARDSC/

CIP-9079

BID NO. SHT. DES L302 DWG NO.

SHEET 26 OF 40

-13 P3 56-

P1

P4 -

P2

CMU WALL

P3 P4

CMU WALL

SF# SITE FURNITURE - REFER TO 'SITE FURNITURE SCHEDULE'

A. REFER TO L300 FOR GENERAL NOTES AND CONSTRUCTION SCHEDULE B. PROVIDE 18" SLIP DOWELS AT INTERFACE BETWEEN EXISTING PAVING AND PROPOSED PAVING.

C. REFER TO CIVIL DRAWINGS FOR DEMOLITION AND GRADING PROJECT ENGINEER: R.C.E. EXP.

MATERIAL SCHEDULE REFERENCE CALLOUTS M# MISCELLANEOUS MATERIAL — REFER TO 'MISCELLANEOUS MATERIALS SCHEDULE' SCORE JOINT **P#** PAVING - REFER TO 'PAVING SCHEDULE' PLANTING AREA ALIGN EDGES L# LIGHT - REFER TO 'LIGHTING SCHEDULE' RIGHT OF WAY

DATE

HORIZ: 1"=20' VERT: 1"=4'

SYMBOL LEGEND

BIKE LANE

P3

P4

CMU WALL

— ISOLATION / CONST. JOINT — CONCRETE PAVING — CONCRETE CURB

CONCRETE PAVING

CMU WALL




P3 P2 P4

CMU WALL

HARDSCAPE FINISH PLAN

SCALE" 1" =20'-0"

CMU WALL

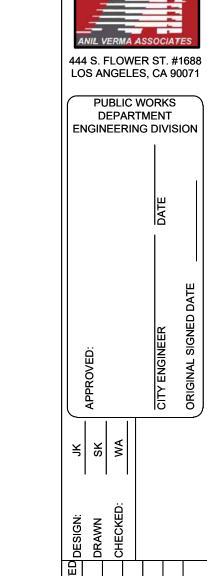


SOUTH LAPROJECTHARDS

CIP-9079

BID NO. SHT. DES L303 DWG NO.

SHEET 27 OF 40

PROJECT ENGINEER: R.C.E. EXP.

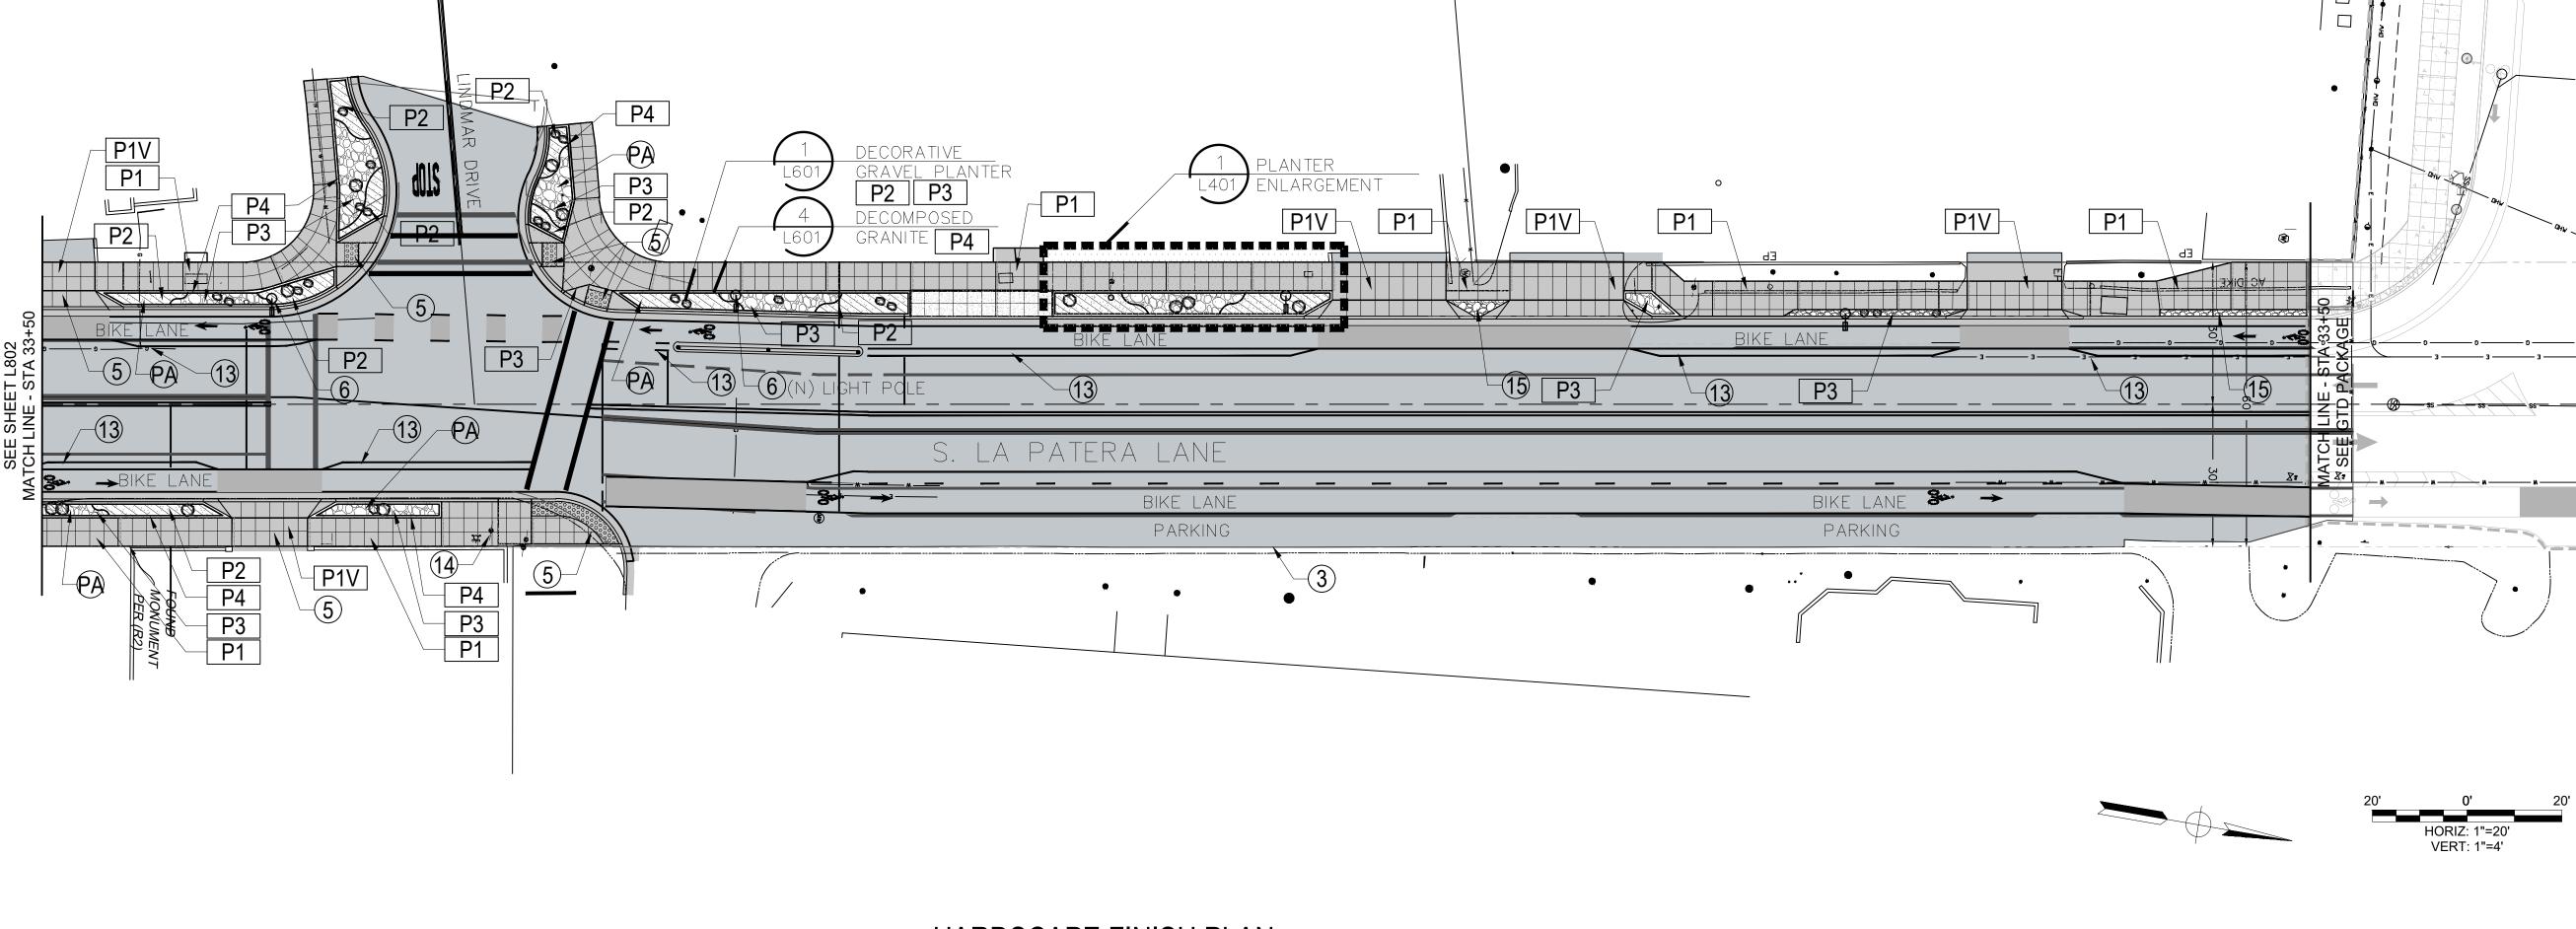

HARDSCAPE FINISH PLAN

SCALE" 1" =20'-0"

SYMBOL LEGEND

PLANTING AREA ALIGN EDGES R/W RIGHT OF WAY

SCORE JOINT ISOLATION / CONST. JOINT
CONCRETE PAVING
CONCRETE CURB

MATERIAL SCHEDULE REFERENCE CALLOUTS

P# PAVING - REFER TO 'PAVING SCHEDULE'

L# LIGHT - REFER TO 'LIGHTING SCHEDULE'

M# MISCELLANEOUS MATERIAL — REFER TO 'MISCELLANEOUS MATERIALS SCHEDULE' SF# SITE FURNITURE — REFER TO 'SITE FURNITURE SCHEDULE'

NOTES

- A. REFER TO L300 FOR GENERAL NOTES AND CONSTRUCTION SCHEDULE B. PROVIDE 18" SLIP DOWELS AT INTERFACE BETWEEN EXISTING PAVING
- AND PROPOSED PAVING.

 C. REFER TO CIVIL DRAWINGS FOR DEMOLITION AND GRADING

03-04-24 DATE



ANIL VERMA ASS	OCIATE
444 S. FLOWER LOS ANGELES,	
PUBLIC WO DEPARTMI ENGINEERING I	ENT
	DATE
PROVED:	TY ENGINEER

SOUTH LA F PROJECT (HARDSCAPE F CIP-9079

BID NO. SHT. DES. L401 DWG NO.

SHEET 28 OF 40


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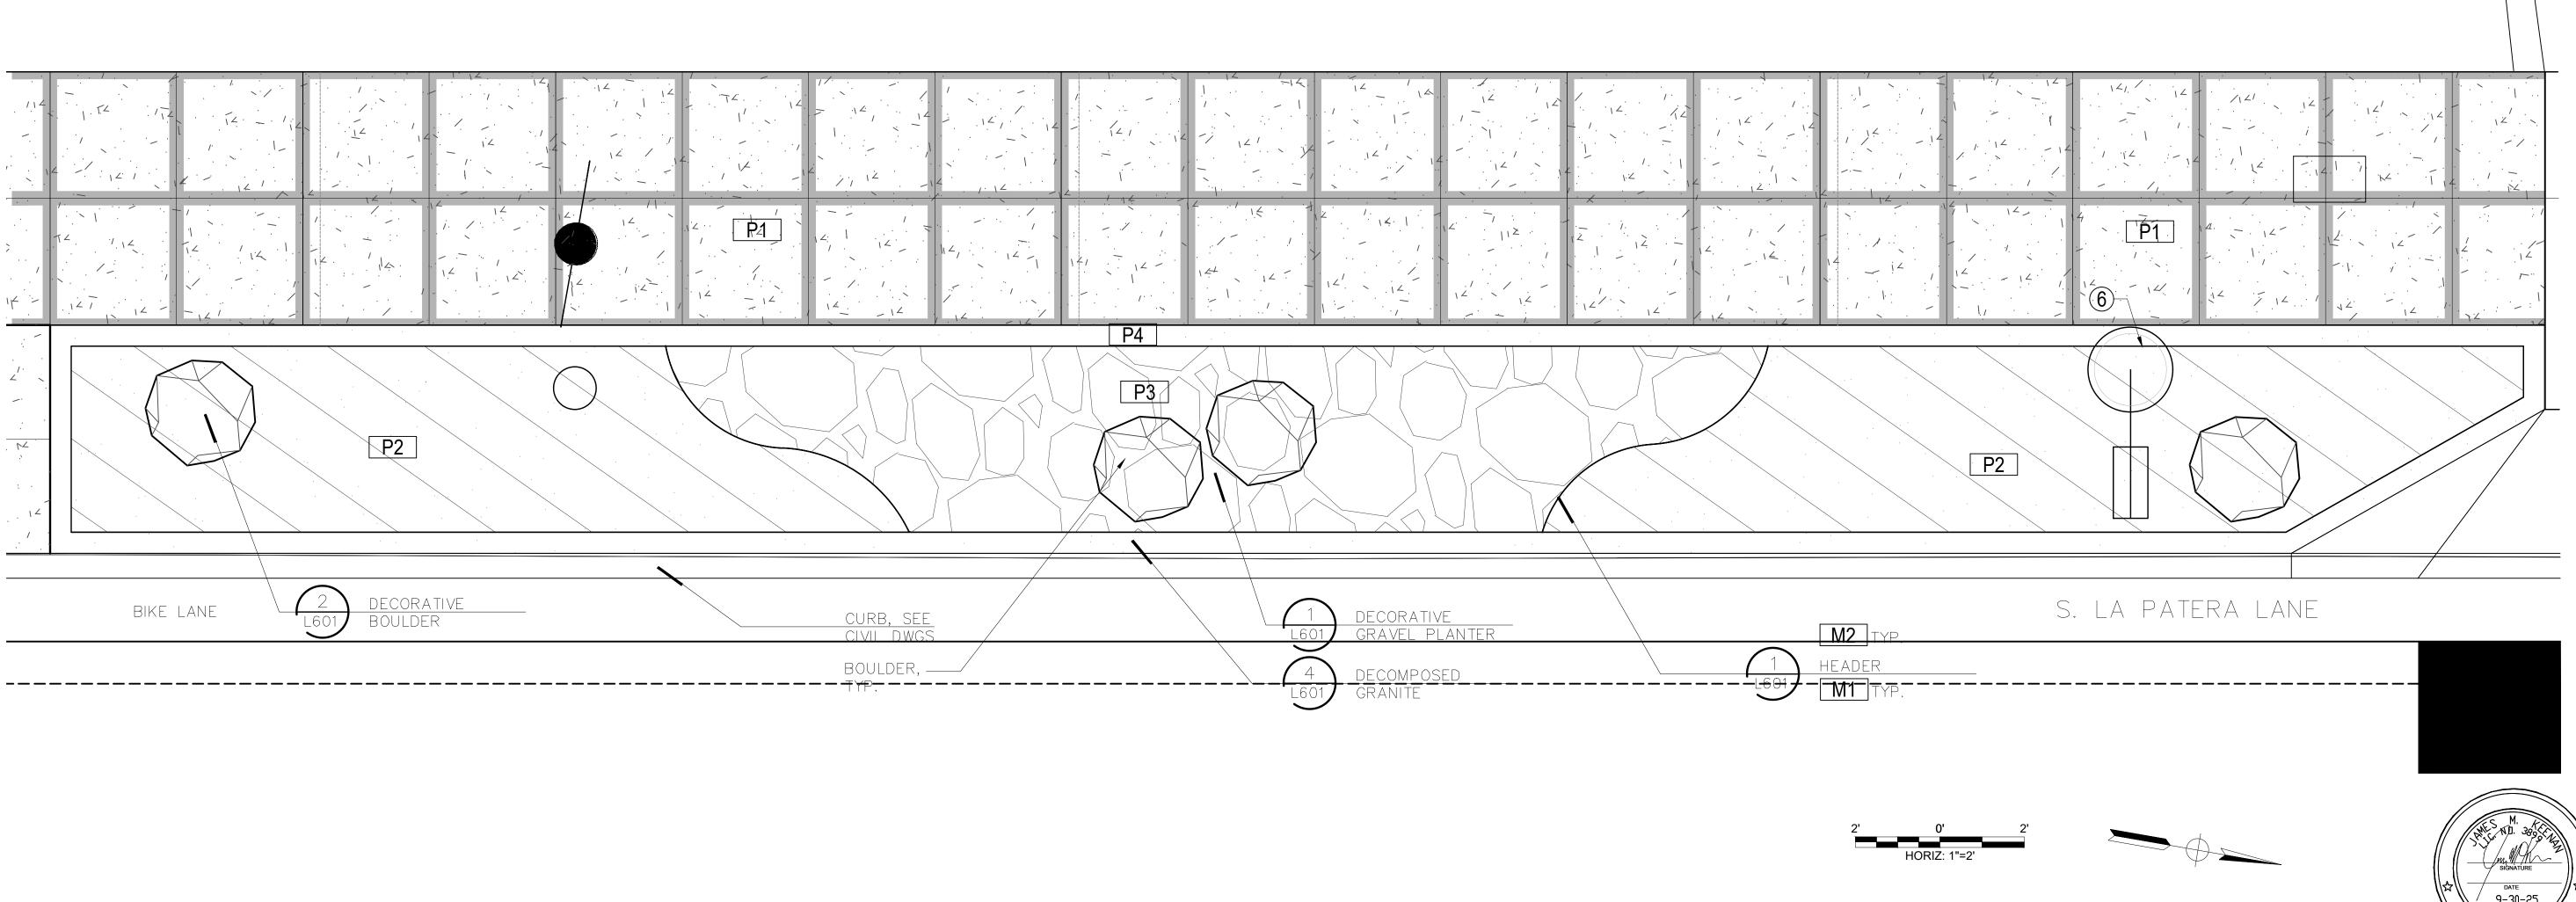
PROJECT ENGINEER: R.C.E. EXP.







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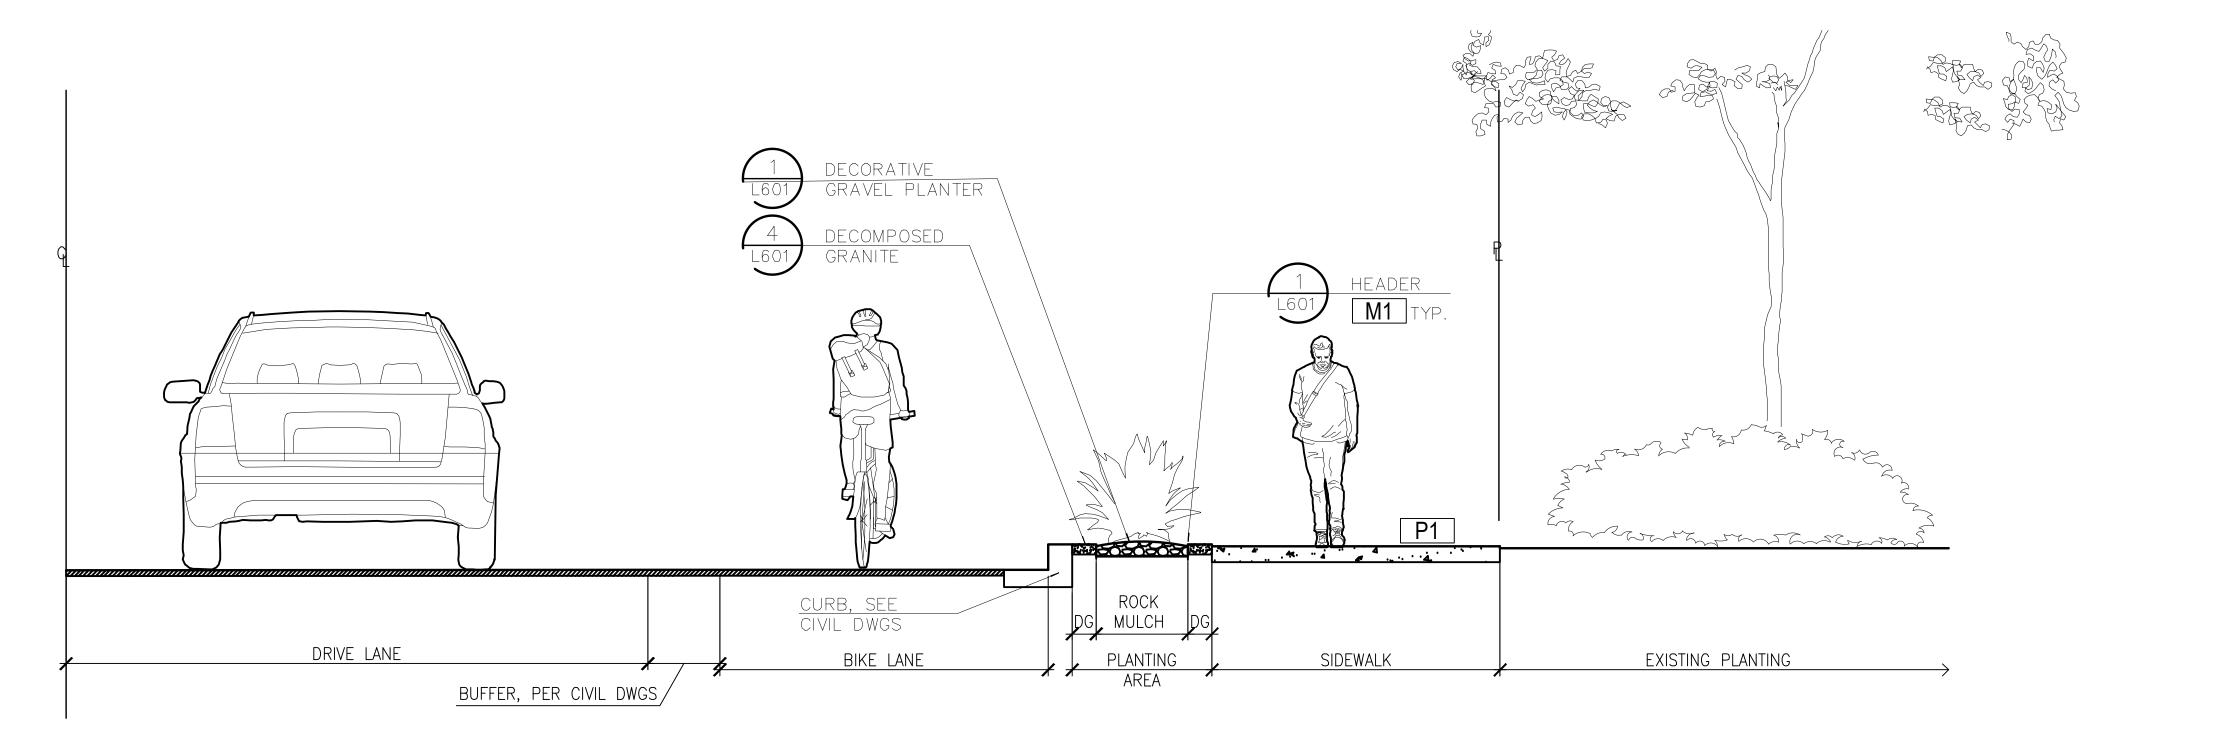


PUBLIC WORKS
DEPARTMENT
ENGINEERING DIVISION

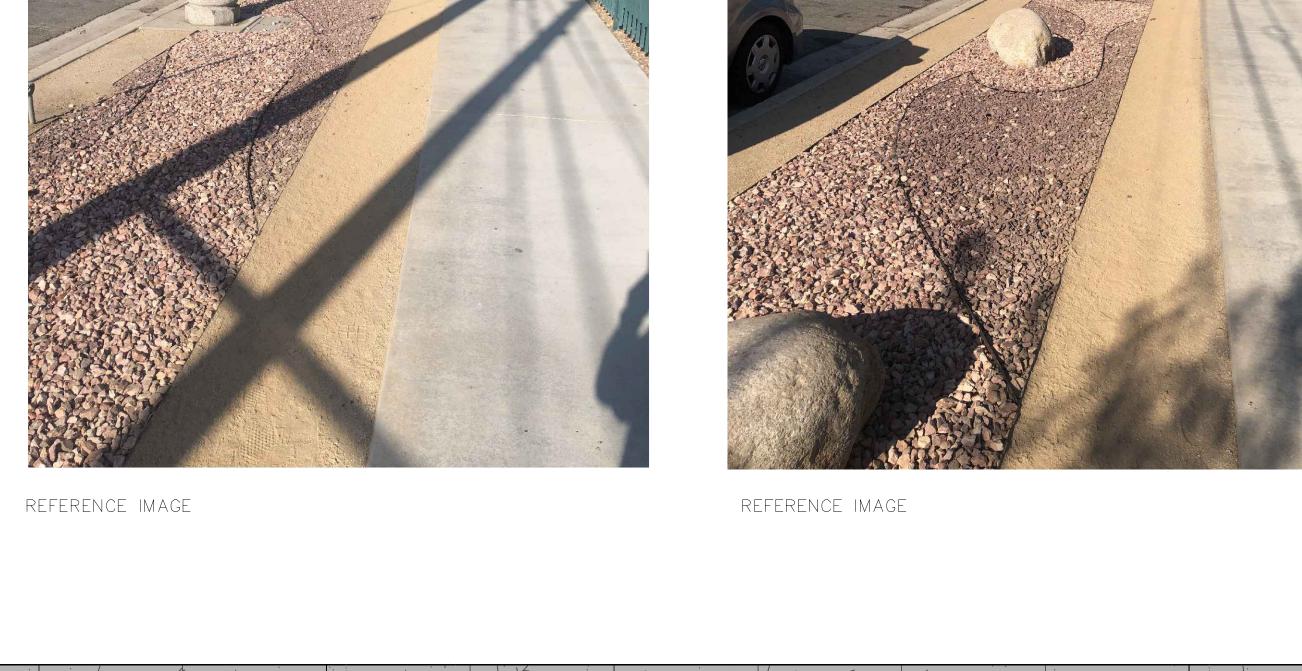

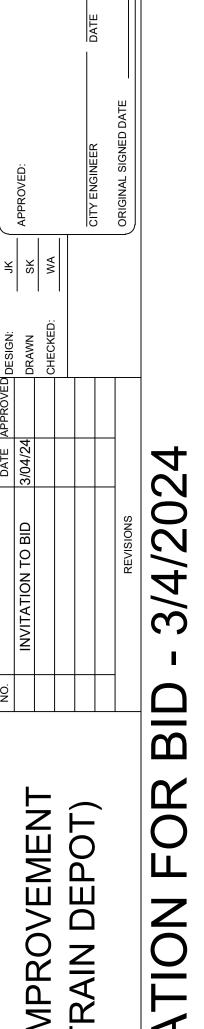TYPICAL BOULEVARD

SCALE: 1/4" = 1'-0"

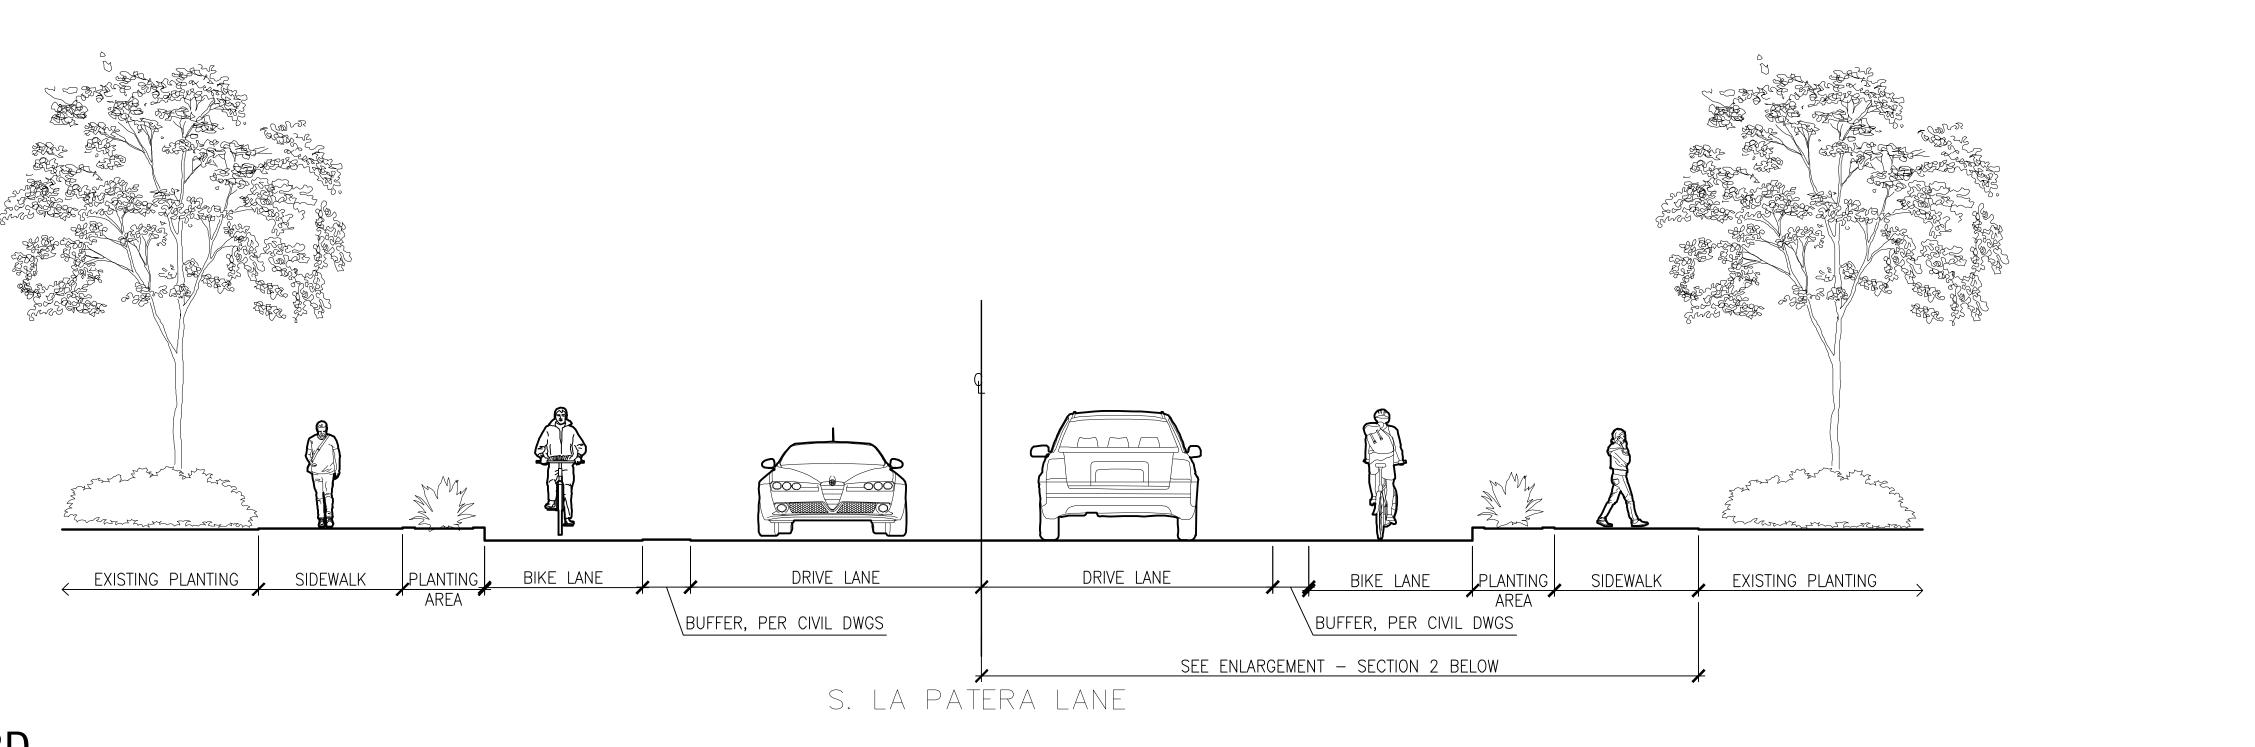

TYPICAL BOULEVARD ENLARGEMENT

SCALE: 1/2" = 1'-0"

03-04-24 DATE


PROJECT ENGINEER: R.C.E. EXP.

CIP-9079

BID NO. SHT. DES

L501DWG NO.

SHEET 29 OF 40

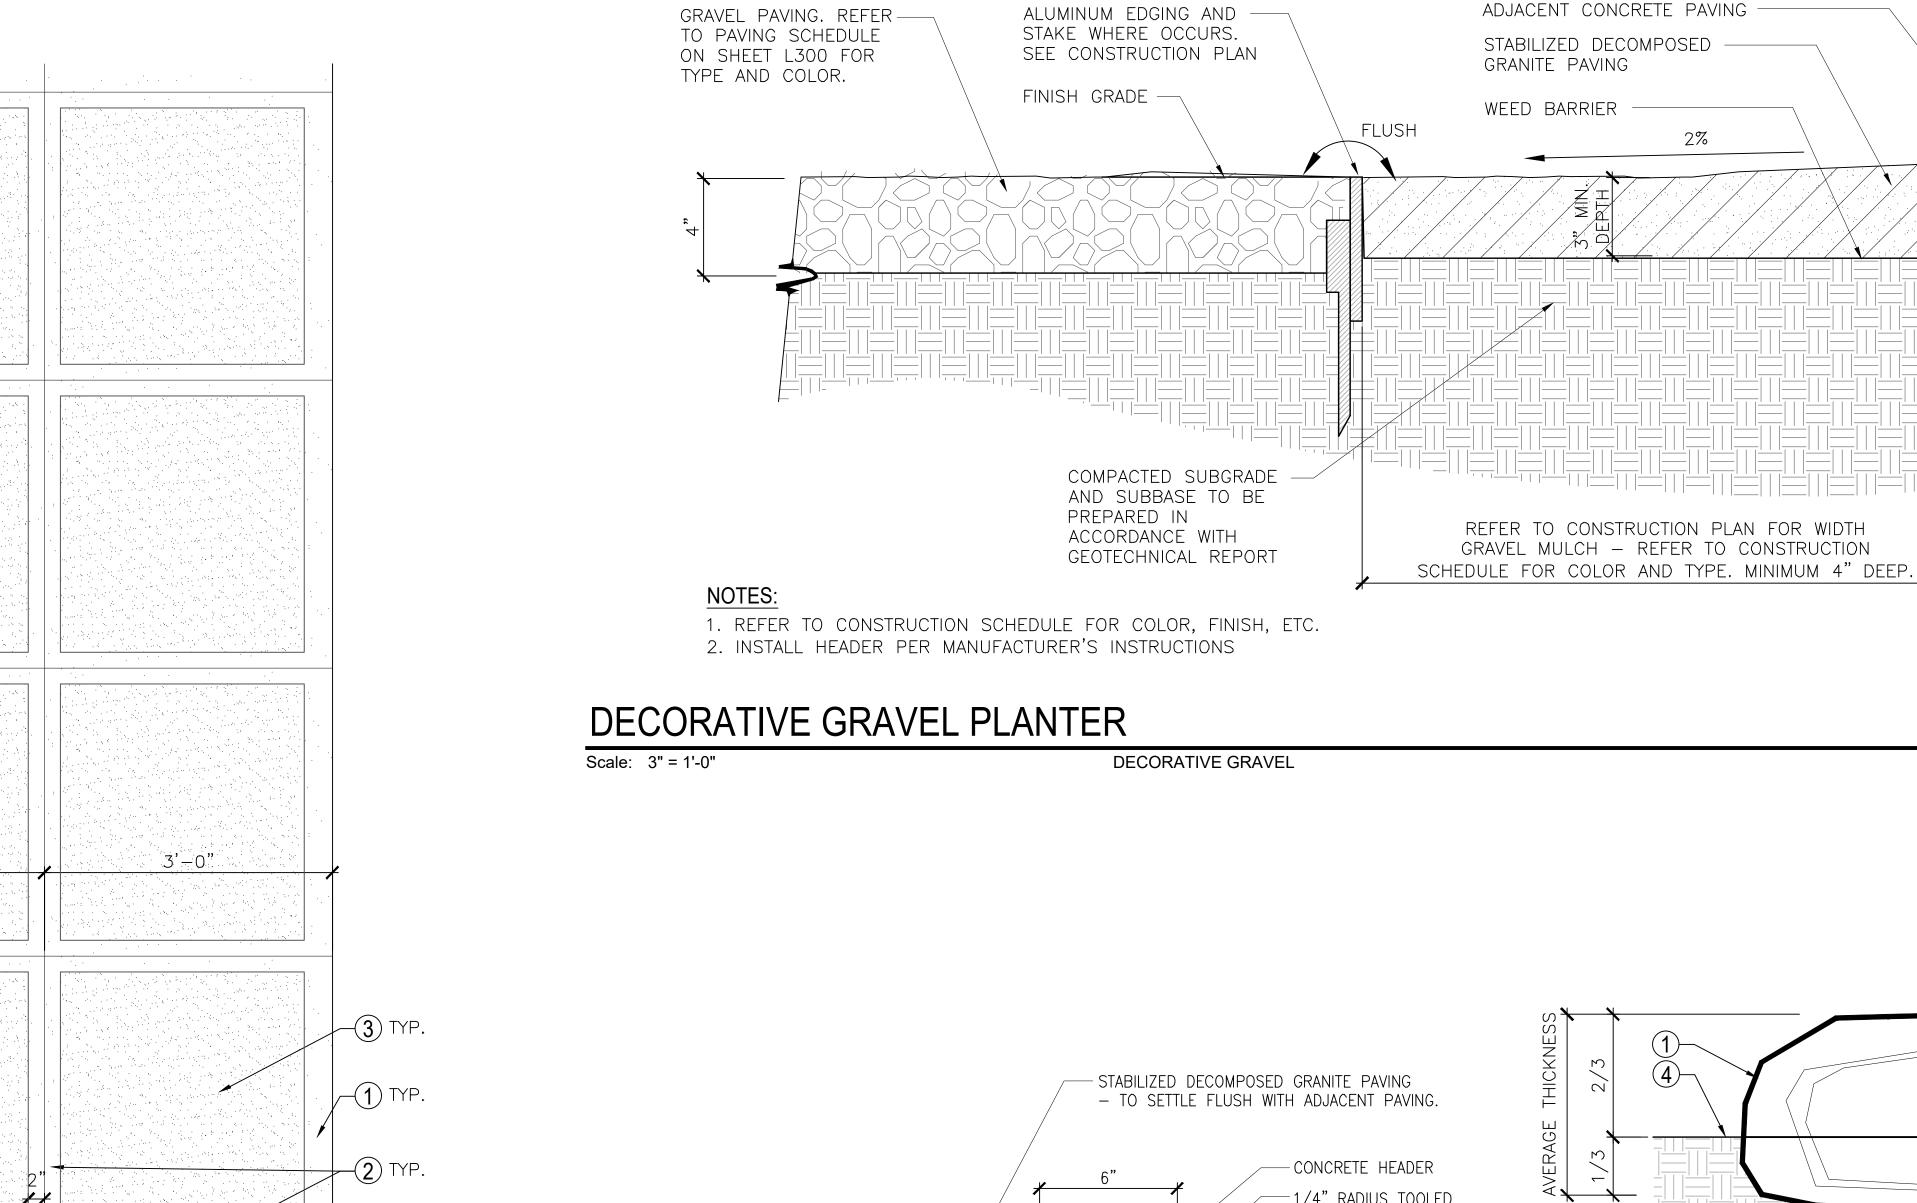


LEGEND 1. 4" SHINER

- 2. 2" SHINER
- 3. NATURAL GRAY CONCRETE, BROOM FINISH

PAVING PATTERN, TYP. (ADD ALT)

3'-0"


SCALE: 1" = 1'-0"

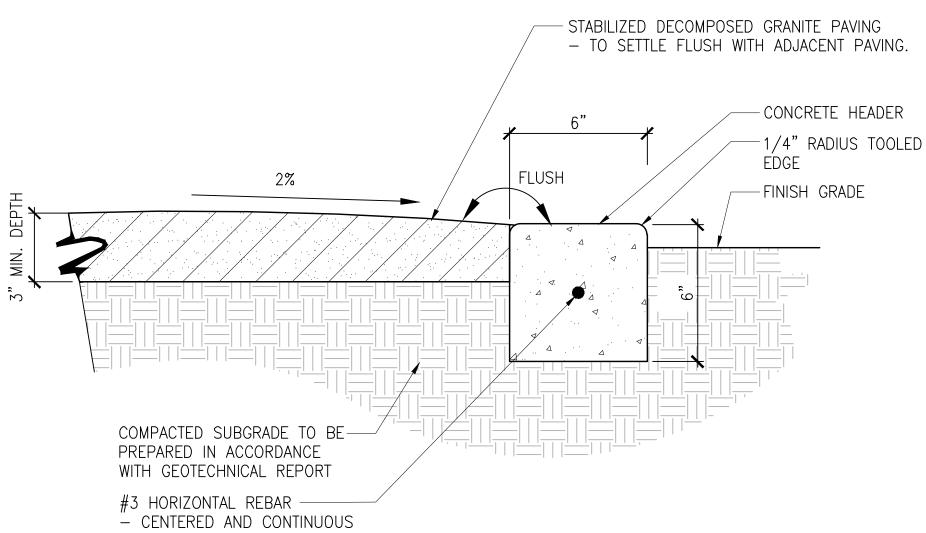

1. REFER TO CONSTRUCTION SCHEDULE FOR COLOR, FINISH, ETC.

DECOMPOSED GRANITE

SCALE: 3" = 1'-0"

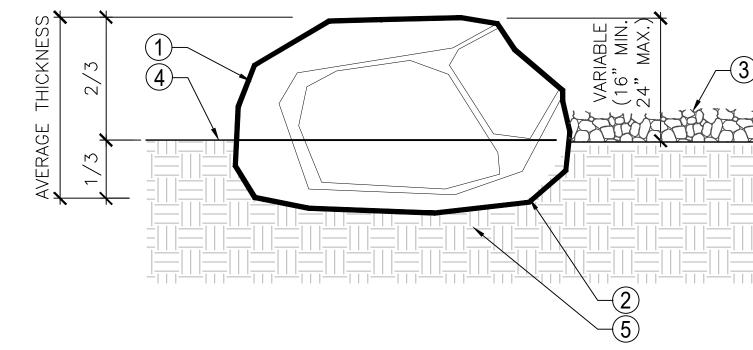

LEGEND

- NATURAL BOULDER. BURY ¹/₃ OF AVERAGE THICKNESS BELOW GRADE. FINAL PLACEMENT TO BE DIRECTED IN THE FIELD BY LANDSCAPE ARCHITECT
 PLACE SCARRED AND/OR DAMAGE FACE DOWN
- ADJACENT DECORATIVE GRAVEL, WHERE OCCURS
- 4. ADJACENT FINISH GRADE OF PLANTING AREA 5. SUBGRADE COMPACTED AT 90%

NOTE:

A. COLOR, FINISH, ETC. — REFER TO L300, CONSTRUCTION SCHEDULE
B. ANY BOULDERS DAMAGED, SCARRED, OR MISHANDLED DURING TRANSPORTATION OR UNLOADING ARE SUBJECT TO REJECTION AND REPLACEMENT.

DECORATIVE BOULDER

SCALE: 1" = 1'-0"



DATE

CIP-9079 BID NO. SHT. DES L601

PUBLIC WORKS DEPARTMENT ENGINEERING DIVISION

3/4/2024

NE IMPROVEMENT ETA TRAIN DEPOT) Details

SOUTH LA PROJECT

03-04-24 PROJECT ENGINEER:

SHEET 30 OF 40

3/4/2024 INVITATION FOR

TREE LEGEND - Sunset Western Garden Zone 4							
SYMBOLS	BOTANIC NAME	COMMON NAME	SIZE	SPACING	QUANTITY	WATER USAGE	REMARKS
	GP Geijera parviflora	Australian Willow	36" Box	per plan	30	Low	Standard High branching
+	TI Tabebuia impetiginosa	Pink Trumpet Tree	36" Box	per plan	8	Low	Standard High branching
	Existing Tree (Protect in Place)	Refer to Arborist Report	_	_	-		Refer to Tree Protection Notes on L801. Refer to Arborist Report

SHRUB LEGEND

_	SYMBOL		BOTANICAL NAME	COMMON NAME	SIZE	SPACING	QUANTITY	PAVING SETBACK	WATER U
	SHRUBS								
	\oplus	BG	Bouteloua gracilis — Blonde Ambition	Blonde Ambition Grama Grass	1 gal.	24" o.c.	119	18"	Low
	\otimes	DB	Dudleya brittonii	Giant Chalk Dudleya	1 gal.	18" o.c.	64	12	Low
	0	GS	Grindelia stricta — Venulosa	Coastal Gum Plant	1 gal.	18" o.c.	83	12"	Low

EXISTING TREE PROTECTION NOTES

- 1. CONTRACTOR SHALL NOT ALTER GRADES AT THE BASE OF TRUNKS OF EXISTING TREES TO BE PROTECTED IN PLACE, FINISH GRADE SHALL BE ADJUSTED TO COVER EXISTING EXPOSED ROOTS AS MUCH AS POSSIBLE WITHOUT ALTERING SURFACE DRAINAGE.
- 2. NO CONSTRUCTION EQUIPMENT SHALL BE STORED UNDER DRIP LINES OF EXISTING OR INSTALLED TREES. EXCESSIVE COMPACTION SHALL BE AVOIDED IN THESE AREAS. FINISH GRADE AREA UNDER CANOPY OF TREE SHALL BE TAPED OFF TO PREVENT EQUIPMENT FROM RUNNING UNDER TREES. AREA UNDER CANOPY SHALL NOT BE USED FOR STORAGE OF ANY MATERIAL AT ANY TIME.
- 3. ROOTS 2" AND DIAMETER AND SMALLER THAT ARE ENCOUNTERED WHILE TRENCHING SHALL BE CLEANLY CUT (AFTER APPROVAL BY CITY ARBORIST) WITH LOPPERS OR A FINE BLADED SAW TO AVOID BREAKING OR TEARING THE ROOT BACK CLOSER TO THE TRUNK. WHEN CUTTING, DO NOT TEAR THE OUTER BARK COVERING THE ROOT. AREAS AROUND LARGE ROOTS, (LARGER THAN 2" IN DIAMETER) ENCOUNTERED DURING TRENCHING SHALL BE HAND WORKED. LARGE ROOTS EXPOSED DURING TRENCHING SHALL BE PROTECTED BY COVERING THEM WITH MOISTENED BURLAP. THEY SHALL BE COVERED WITH MOIST BURLAP THE DURATION THE TRENCH IS EXCAVATED. CONTRACTOR IS RESPONSIBLE FOR MAINTAINING MOISTURE IN BURLAP THE ENTIRE TIME THE ROOT IS EXPOSED. THE CONTRACTOR SHALL TAKE DIGITAL PHOTOS OF ROOTS THAT ARE PRUNED/ SEVERED FOR OWNER'S RECORDS AND TO SUBSTANTIATE PROPER METHODS OF WORK. THESE PHOTOS SHALL BE COPIED ONTO A CD AND FORWARDED TO THE OWNER'S AUTHORIZED REPRESENTATIVE SUBSEQUENT TO COMPLETION OF WORK.
- 4. NO TREE REMOVAL IS ALLOWED UNLESS APPROVED ON YOUR SITE PLAN. NO DAMAGE TO TREE ROOT SYSTEMS IS ALLOWED. NO HEAVY EQUIPMENT AND STOCKPILING OF MATERIALS WITHIN TREE DRIP LINES. ANY ADDITIONAL TREE REMOVAL MUST BE AUTHORIZED BY THE PLANNING DEPARTMENT PRIOR TO REMOVAL. CALL THE PLANNER NOTED ABOVE FOR MORE INFORMATION.
- 5. ANY ADDITIONAL TREE REMOVAL MUST BE AUTHORIZED BY THE PLANNING DEPARTMENT PRIOR TO REMOVAL. CALL THE PLANNER NOTED ABOVE FOR MORE INFORMATION.
- PROVIDE TREE PROTECTION FENCING AS PER CITY OF GOLETA STANDARD DETAIL
- 7. ALL PLANTING AREAS THAT ARE DISTURBED BY TRENCHING AND EXCAVATING SHALL BE BROUGHT BACK TO FINISH GRADE READY FOR PLANTING. GRADE SHALL BE COMPACTED AND DEVOID OF ANY ROCKS 1" DIAMETER AND LARGER WITHIN 6" OF SURFACE OR ANY DELETERIOUS MATERIAL. CONTRACTOR SHALL ENSURE THAT PROPER FLOW LINES ARE MAINTAINED/ CREATED TO ENSURE THAT WATER DOES NOT POND AT TREE BASE.
- 8. ALL EXISTING UTILITIES AND HARDSCAPE ELEMENTS (CURBS, SIDEWALKS, ETC) ARE TO BE PROTECTED IN PLACE UNLESS OTHERWISE NOTED. CONTRACTOR TO REPAIR AND/OR REPLACE ALL HARDSCAPE ELEMENTS DAMAGED IN AREAS OUTSIDE THE LIMIT OF LANDSCAPE WORK, OR NOTED AS PROTECT IN PLACE TO THE SATISFACTION OF THE OWNER OR OWNER'S REPRESENTATIVE AT NO COST TO THE OWNER

GENERAL PLANTING NOTES

- 1. REFER TO PLANTING PLAN, DETAILS, AND SPECIFICATIONS FOR ADDITIONAL PLANTING INFORMATION
- 2. THE CONTRACTOR SHALL BE RESPONSIBLE FOR MAKING HIMSELF FAMILIAR WITH ALL UNDERGROUND UTILITIES AND STRUCTURES. THE CONTRACTOR SHALL TAKE SOLE RESPONSIBILITY FOR ANY COST INCURRED DUE TO DAMAGE OF SAID UTILITIES OR STRUCTURES
- 3. DO NOT WILLFULLY PROCEED WITH PLANTING OPERATIONS AS DESIGNED WHEN IT IS OBVIOUS THAT UNKNOWN OBSTRUCTIONS AND/OR GRADE DIFFERENCES EXIST THAT MAY NOT HAVE BEEN KNOWN DURING THE DESIGN PROCESS. SUCH CONDITIONS SHALL BE IMMEDIATELY BROUGHT TO THE ATTENTION OF THE OWNER AUTHORIZED REPRESENTATIVE. THE CONTRACTOR SHALL ASSUME FULL RESPONSIBILITY FOR ALL NECESSARY REVISIONS DUE TO THE FAILURE TO GIVE SUCH NOTIFICATION PRIOR TO BEGINNING WORK
- 4. WHERE IT IS OBVIOUS IN THE FIELD THAT CONDITIONS DEVIATE FROM WHAT IS INDICATED ON THE PLANS, IT IS THE RESPONSIBILITY OF THE CONTRACTOR TO NOTIFY THE LANDSCAPE ARCHITECT OF THESE DISCREPANCIES. IN THE EVENT THIS NOTIFICATION IS NOT PERFORMED, THE CONTRACTOR SHALL ASSUME ALL RESPONSIBILITY FOR ANY NECESSARY REVISIONS
- 5. VERIFY AND NOTE LOCATION AND DEPTH OF ALL UNDERGROUND UTILITIES PRIOR TO START OF WORK. PERFORM WORK IN A MANNER WHICH WILL AVOID POSSIBLE DAMAGE. HAND EXCAVATE AS
- 6. THE CONTRACTOR SHALL BE RESPONSIBLE FOR ANY COORDINATION WITH SUBCONTRACTORS AS REQUIRED TO ACCOMPLISH PLANTING OPERATIONS
- 7. IF CONFLICTS ARISE BETWEEN THE ACTUAL SIZE OF AREAS ON THE SITE AND THE PLANS, CONTACT THE GENERAL CONTRACTOR FOR RESOLUTION. UNLESS OTHERWISE DIRECTED, THE CONTRACTOR SHALL ASSUME THE MORE EXPENSIVE OF THE TWO OPTIONS
- 8. PLANT QUANTITIES LABELED ON ALL PLANS ARE FOR IN-HOUSE REFERENCE PURPOSES ONLY. THE PLANT SPACING SHOWN ON THE PLANTING LEGEND SHALL TAKE PRECEDENCE DURING BIDDING AND CONSTRUCTION PHASES. THE ONUS IS UPON THE CONTRACTOR TO CALCULATE FINAL PLANT QUANTITIES. ANY DISCREPANCY SHALL BE CALLED TO THE ATTENTION OF THE LANDSCAPE ARCHITECT IMMEDIATELY
- 9. PROVIDE TREES, SHRUBS, AND PLANTS OF QUALITY, SIZE, GENUS, SPECIES AND VARIETY SHOWN AND SCHEDULED FOR LANDSCAPE WORK AND COMPLYING WITH RECOMMENDATIONS AND REQUIREMENTS OF ANSI 760.1 "AMERICAN STANDARD FOR NURSERY STOCK". PROVIDE HEALTHY. VIGOROUS STOCK, GROWN IN A RECOGNIZED NURSERY IN ACCORDANCE WITH GOOD HORTICULTURAL PRACTICE AND FREE OF DISEASE, INSECTS, EGGS, LARVAE, AND DEFECTS SUCH AS KNOTS, SUN-SCALD, INJURIES, ABRASIONS OR DISFIGUREMENT. HEIGHT AND WIDTH SHOWN ARE MINIMUM SIZES
- 10. ALL TREE & SHRUB MATERIAL SPECIFIED MUST MEET STANDARD INDUSTRY SPECIFICATIONS FOR THE CONTAINER SIZE INDICATED. IF CONTRACTOR CANNOT LOCATE MATERIAL OF ACCEPTABLE SIZE AT THE TIME OF INSTALLATION. SUBMIT PROOF OF NON-AVAILABILITY FROM A MINIMUM OF 5 SUPPLIERS TO THE LANDSCAPE ARCHITECT FOR REVIEW AND SPECIES SUBSTITUTION. DOWN-SIZING OR SUBSTITUTION OF PLANT MATERIAL WITHOUT PRIOR APPROVAL OF LANDSCAPE ARCHITECT WILL NOT BE ALLOWED
- 11. PROVIDE MATCHING FORMS AND SIZES FOR PLANT MATERIAL WITHIN EACH SPECIES AND SIZE AS DESIGNATED ON PLANS. FURNISH ALL PLANT MATERIALS FREE OF PESTS. DISEASE, AND DAMAGE
- 12. CONTRACTOR SHALL SUBMIT FOR APPROVAL, PHOTOS OF ALL BOXED TREES AND SHRUB, GROUNDCOVER, AND VINES. SEE SPECIFICATIONS FOR FURTHER DETAIL
- 13. A REPRESENTATIVE SAMPLE OF THE BOTANICAL NAME TAGS FURNISHED BY THE NURSERY STOCK SUPPLIER SHALL REMAIN ATTACHED TO THE PLANTS UNTIL FINAL INSPECTION
- 14. CONTRACTOR SHALL SUBMIT A PHYSICAL SAMPLE OF THE FOLLOWING INERT MATERIALS FOR REVIEW BY LANDSCAPE ARCHITECT AND CLIENT PRIOR TO INSTALLATION — MULCH, DECORATIVE
- 15. PRIOR TO PLANTING, PERFORM AGRONOMIC SOIL TESTING AND SOIL AMENDMENTS PER RECOMMENDATION BY SOIL LABORATORIES. REFER TO NOTES BELOW AND SPECIFICATIONS
- 16. THE CONTRACTOR SHALL HAVE SOIL SAMPLES TAKEN FROM NUMBER (#) AREAS IDENTIFIED IN THE DRAWINGS. THE SAMPLES SHALL BE TESTED BY WALLACE LABORATORIES, EL SEGUNDO, FOR SOIL FERTILITY, AGRICULTURAL SUITABILITY, N-P-K, pH, EC, SOIL TEXTURE (SILT, CLAY, SAND) AND SOIL PRÉPARATION RECOMMENDATIONS. THE CONTRACTOR MAY BE REQUESTÉD TO AMEND THE SOIL TO CONFORM TO THESE RECOMMENDATIONS. ANY AMENDMENT HOWEVER, WOULD BE REQUESTED OF THE CONTRACTOR ONLY UPON WRITTEN RECEIPT OF CHANGE ORDER FROM THE OWNER. THE RESULTS AND RECOMMENDATIONS OF THE SOIL TESTING LABORATORY SHALL BE SUBMITTED TO AND APPROVED BY THE OWNER. THE APPROVED RECOMMENDATIONS FOR AMENDMENTS AND BACKFILL SHALL BE INCORPORATED INTO THE LANDSCAPE PLANTING AREAS PRIOR TO THE START OF CONSTRUCTION AND SHALL BECOME PART OF THE APPROVED PLANS
- 17. THE CONTRACTOR SHALL HAVE SOIL SAMPLES TAKEN OF EACH SHIPMENT OF IMPORT SOIL TO THE SITE, EVEN SAMPLES BROUGHT FROM OTHER LOCATIONS ON SITE. THE SAMPLES SHALL BE TESTED BY A QUALIFIED SOILS TESTING LABORATORY FOR SOIL FERTILITY, AGRICULTURAL SUITABILITY, AND SOIL PREPARATION RECOMMENDATIONS. EACH SOIL SAMPLE SHALL CONTAIN APPROXIMATELY ONE (1) QUART OF SOIL. THE CONTRACTOR MAY BE REQUESTED TO AMEND THE SOIL TO CONFORM TO THESE RECOMMENDATIONS


- 18. AT LOCATIONS WHERE EXISTING PAVING/SLABS ARE REMOVED AND INSTALLATION OF NEW PLANTING AREAS IS INDICATED, CONTRACTOR SHALL REMOVE THE TOP 24 INCHES (DEPTH) OF SOIL BELOW BASE AND REPLACE TO A 24 INCH DEPTH WITH TESTED AND OAR APPROVED IMPORTED PLANTING SOIL.
- 19. FINISH GRADE IN ALL PLANTER AREAS SHALL BE 2 INCHES BELOW FINISH SURFACE OF SURROUNDING HARDSCAPE AND/OR UTILITY BOXES, EXCEPT WHERE NOTED
- 20. PERFORM WEED CONTROL PER PLANTING SPECIFICATIONS. PROVIDE MANUAL WATERING VIA WATERING TRUCK FOR ESTABLISHMENT PURPOSES.
- 21. PRIOR TO PLANTING, TREAT ALL PLANTING BEDS WITH PRE-EMERGENT HERBICIDE. CONTRACTOR IS RESPONSIBLE FOR ALL WEEDING UNTIL FINAL ACCEPTANCE
- 22. LOCATIONS OF ALL PLANT BEDS AND TREES TO BE STAKED AND APPROVED BY LANDSCAPE ARCHITECT PRIOR TO PLANTING
- 23. TREE LOCATIONS SHOWN ON PLAN MAY REQUIRE ADJUSTMENT IN THE FIELD. WHENEVER FEASIBLE, TREES SHOULD BE PLANTED A MINIMUM OF TEN (10) FEET FROM ALL UNDERGROUND UTILITIES AND OUT OF DRAINAGE FLOW LINES AND THREE (3) FEET FROM SPRAY HEADS. SHOULD THIS NOT BE POSSIBLE, CONTACT THE LANDSCAPE ARCHÍTECT FOR A DECISION ON TREE PLACEMENT
- 24. INSTALL ROOT BARRIER IF CENTER OF TREE TRUNK IS WITHIN 5' OF ANY CURBS OR SIDEWALKS
- 25. SCARIFY ALL TREE PITS BEFORE PLANTING. VERIFY THAT ALL TREE PITS ADEQUATELY DRAIN BEFORE PLANTING TREES
- 26. DELIVER TREES AND SHRUBS AFTER PREPARATIONS FOR PLANTING HAS BEEN COMPLETED AND PLANT IMMEDIATELY. IF PLANTING IS DELAYED MORE THAN 6 HOURS AFTER DELIVERY, SET TREES AND SHRUBS IN SHADE, PROTECT FROM WEATHER AND MECHANICAL DAMAGE,´AND KEEP ROOTS MOIST BY COVERING WITH MULCH, BURLAP, OR OTHER ACCEPTABLE MEANS OF RETAINING
- 27. 15 GALLON SIZE TREES ARE TO BE SINGLE STAKED. 24" BOX & 36" BOX SIZE TREES TO BE DOUBLE STAKED UNLESS OTHERWISE NOTED. 48" BOX SIZED TREES AND LARGER ARE TO BE EITHER GUYED OR DOUBLE STAKED UPON DIRECTION FROM THE OWNER'S AUTHORIZED REPRESENTATIVE
- 28. TRIANGLE SPACE SHRUBS AND GROUNDCOVER UNLESS INDICATED OTHERWISE ON PLANS. ALIGN AND EQUALLY SPACE PLANTS IN ALL DIRECTIONS
- 29. WHENEVER A SHRUB AREA ABUTS A PARKING STALL, PROVIDE A 2' PLANT-FREE "CLEAR ZONE" FROM FACE OF CURB
- 30. DO NOT PLANT ON TOP OF TREE ROOTBALLS UNLESS DIRECTED BY LANDSCAPE ARCHITECT
- 31. INSTALL 3 INCH LAYER OF SHREDDED WOOD MULCH OR DECORATIVE GRAVEL IN ALL NEWLY PLANTED AREAS UPON COMPLETION OF PLANTING. MULCH TO BE "FOREST FLOOR" (1/2"-1)1/2" SIZE) BY AGUINAGA GREEN. REFER TO PLANS FOR LOCATION AND SIZE OF DECORATIVE GRAVEL. REFER TO SPECIFICATIONS FOR ADDITIONAL INFORMATION
- 32. LANDSCAPE ARCHITECT SHALL HAVE THE OPPORTUNITY TO INSPECT AND APPROVE ALL SPECIMEN AND BOX (24" BOX AND LARGER) MATERIALS AT THE NURSERY PRIOR TO PLANTING
- 33. LANDSCAPE ARCHITECT AND CITY OF GOLETA ARBORIST SHALL HAVE THE OPPORTUNITY TO INSPECT ALL PLANT MATERIALS AT THE JOB SITE PRIOR TO PLANTING
- 34. UPON COMPLETION OF PLANTING, THE CONTRACTOR SHALL ARRANGE FOR A SUBSTANTIAL COMPLETION INSPECTION BY THE LANDSCAPE ARCHITECT. CONTRACTOR SHALL CORRECT ANY DISCREPANCIES FOUND PRIOR TO FINAL INSPECTION AND ACCEPTANCE OF THE PROJECT.
- 35. LANDSCAPE IRRIGATION SYSTEM SHALL BE DESIGNED AND MAINTAINED TO PREVENT SPRAY ON STRUCTURES. (Title 31, Section 5.407.2.1)
- 36. ALL TREES SHALL BE INSPECTED BY THE CITY ARBORIST FOR APPROVAL OR REJECTION PRIOR TO

SOIL TESTING

- 1. SEE SPECIFICATIONS.
- 2. CONDUCT ON-SITE SOIL TESTS AT LOCATIONS SHOWN ON DRAWINGS WITH THIS SYMBOL:
- SOIL TEST CONDUCT 2 TESTS PER LOCATION: 1) SAMPLE TAKEN FROM FINISH GRADE SURFACE 2) SAMPLE TAKEN FROM AN 18" SOIL DEPTH
- 3. FOR IMPORTED SOIL, CONDUCT 2 (TWO) TESTS PER SOURCE.

PROJECT ENGINEER:

R.C.E. EXP.

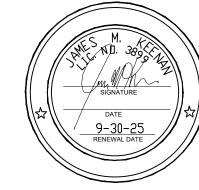

03-04-24

DATE

(iOLET/

444 S. FLOWER ST. #1688


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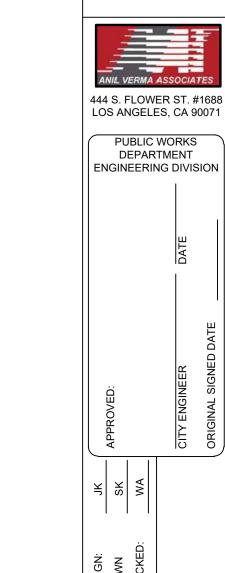
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CIP-9079

BID NO. DWG NO.

SHEET 32 OF 40



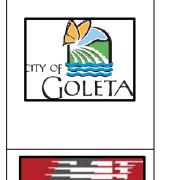

SHRUB (DB)

TREE (GP)

TYP.)

TRAIN DEPOT)
ATERA LANE

TATION FOR SOUTH LA PATERA LANE II
PROJECT (FOR GOLETA T
PLANTING PLAN - LA PA

CIP-9079

BID NO. SHT. DES. L801 DWG NO. SHEET 33 OF 40

9-30-25

03-04-24

DATE

PROJECT ENGINEER: R.C.E. EXP.

SHRUB (GS) SHRUB (BG) SHRUB (BG) (TYP.) TYP.) TYP.) TREE (TI) TYP.) WS CONTROL OF CONTROL TREE (GP) S. LA PATERA LANE TYP.) SHRUB (GS) TYP.) TREE (TI) TREE (GP) SHRUB (DB) SHRUB (GS) TREE (TI) TYP.) TYP.) TYP.) TYP.) TYP.) SHRUB (BG) SHRUB (BG) SHRUB (GS) SHRUB (DB) TYP.) TYP.) TYP.) PLANTING PLAN SCALE" 1" =20'-0" PLANT LEGEND - See Sheet L800 SCALE: 1" = 20'

NOTES:

⊕ BG

○ DB

O GS

REFER TO SHEET L-800 FOR PLANTING LEGEND. REFER TO SHEETS L-1001 FOR TYPICAL PLANTING DETAILS & NOTES

Grindelia stricta — Venulosa

Bouteloua gracilis — Blonde Ambition

BOTANIC NAME

Geijera parviflora

Existing Tree

(Protect in Place)

Dudleya brittonii

Tabebuia impetiginosa

PUBLIC WORKS DEPARTMENT ENGINEERING DIVISION

TRAIN DEPOT)
ATERA LANE

FATION FOR

CITY OF GOL N PATERA LAN F (FOR GOLET TING PLAN - LA

SOUTH LA PROJECT PLANT


CIP-9079 PBW NO.

BID NO. SHT. DES.

L802

DWG NO.

SHEET 34 OF 40

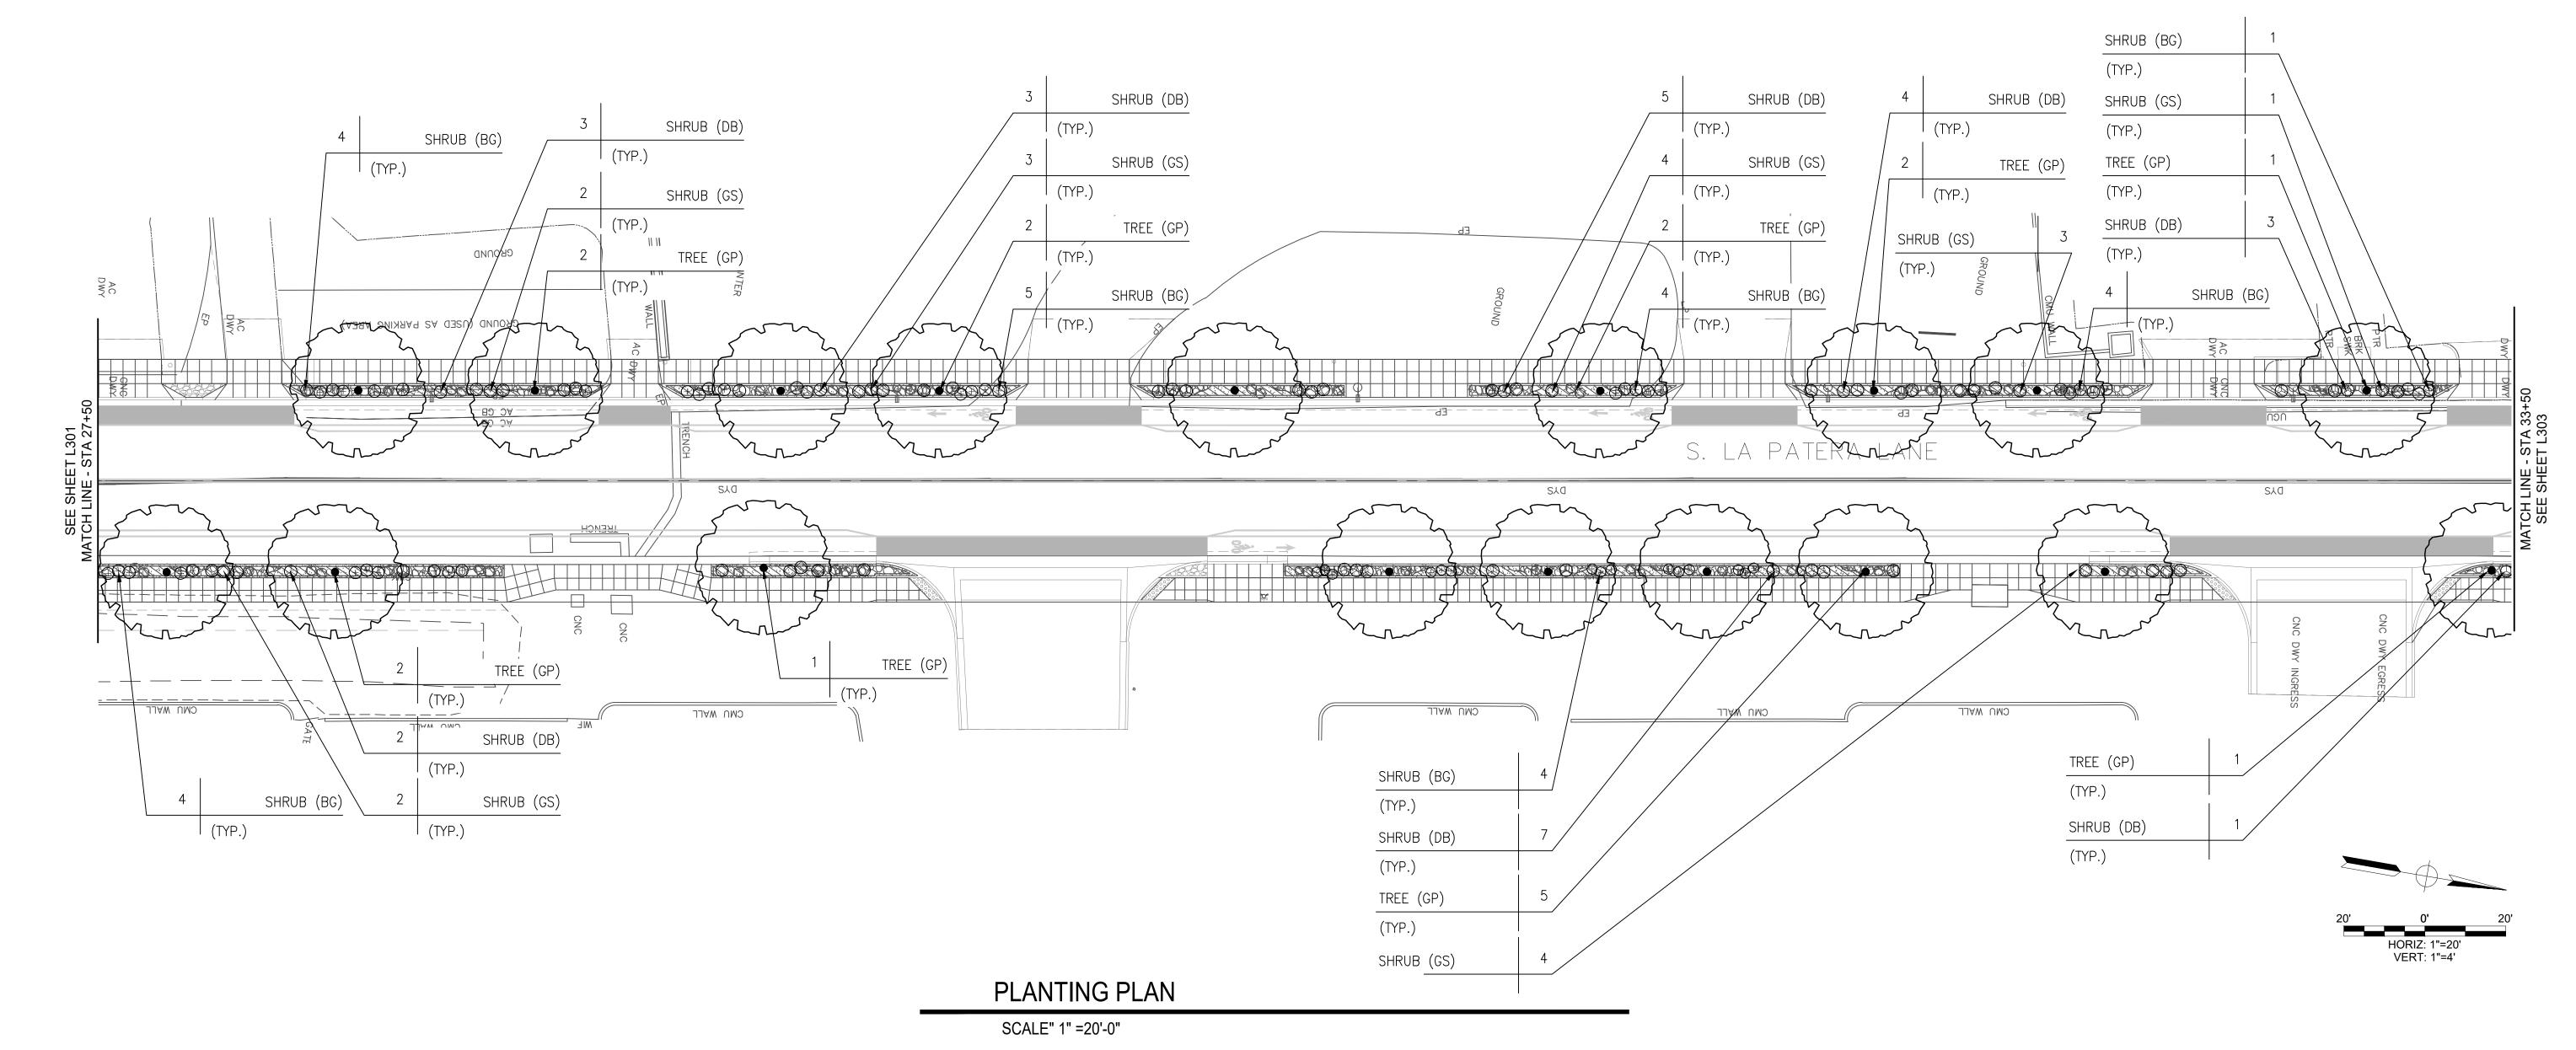

PLANT LEGEND - See Sheet L800

BOTANIC NAME Geijera parviflora Tabebuia impetiginosa Existing Tree (Protect in Place)


⊕ BG Bouteloua gracilis — Blonde Ambition

○ DB Dudleya brittonii

O GS Grindelia stricta — Venulosa


NOTES:

REFER TO SHEET L-800 FOR PLANTING LEGEND. REFER TO SHEETS L-1001 FOR TYPICAL PLANTING DETAILS & NOTES

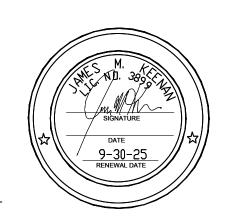

03-04-24 DATE

PROJECT ENGINEER: R.C.E. EXP.

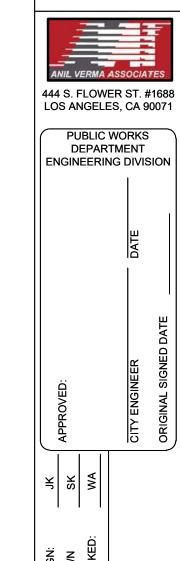

TRAIN DEPOT)
ATERA LANE

FATION FOR CITY OF GOLETA

NOTERA LANE I

FOR GOLETA


TING PLAN - LA PA SOUTH LA I PROJECT PLANTI

CIP-9079

BID NO. SHT. DES. L803 DWG NO.

SHEET 35 OF 40

DATE

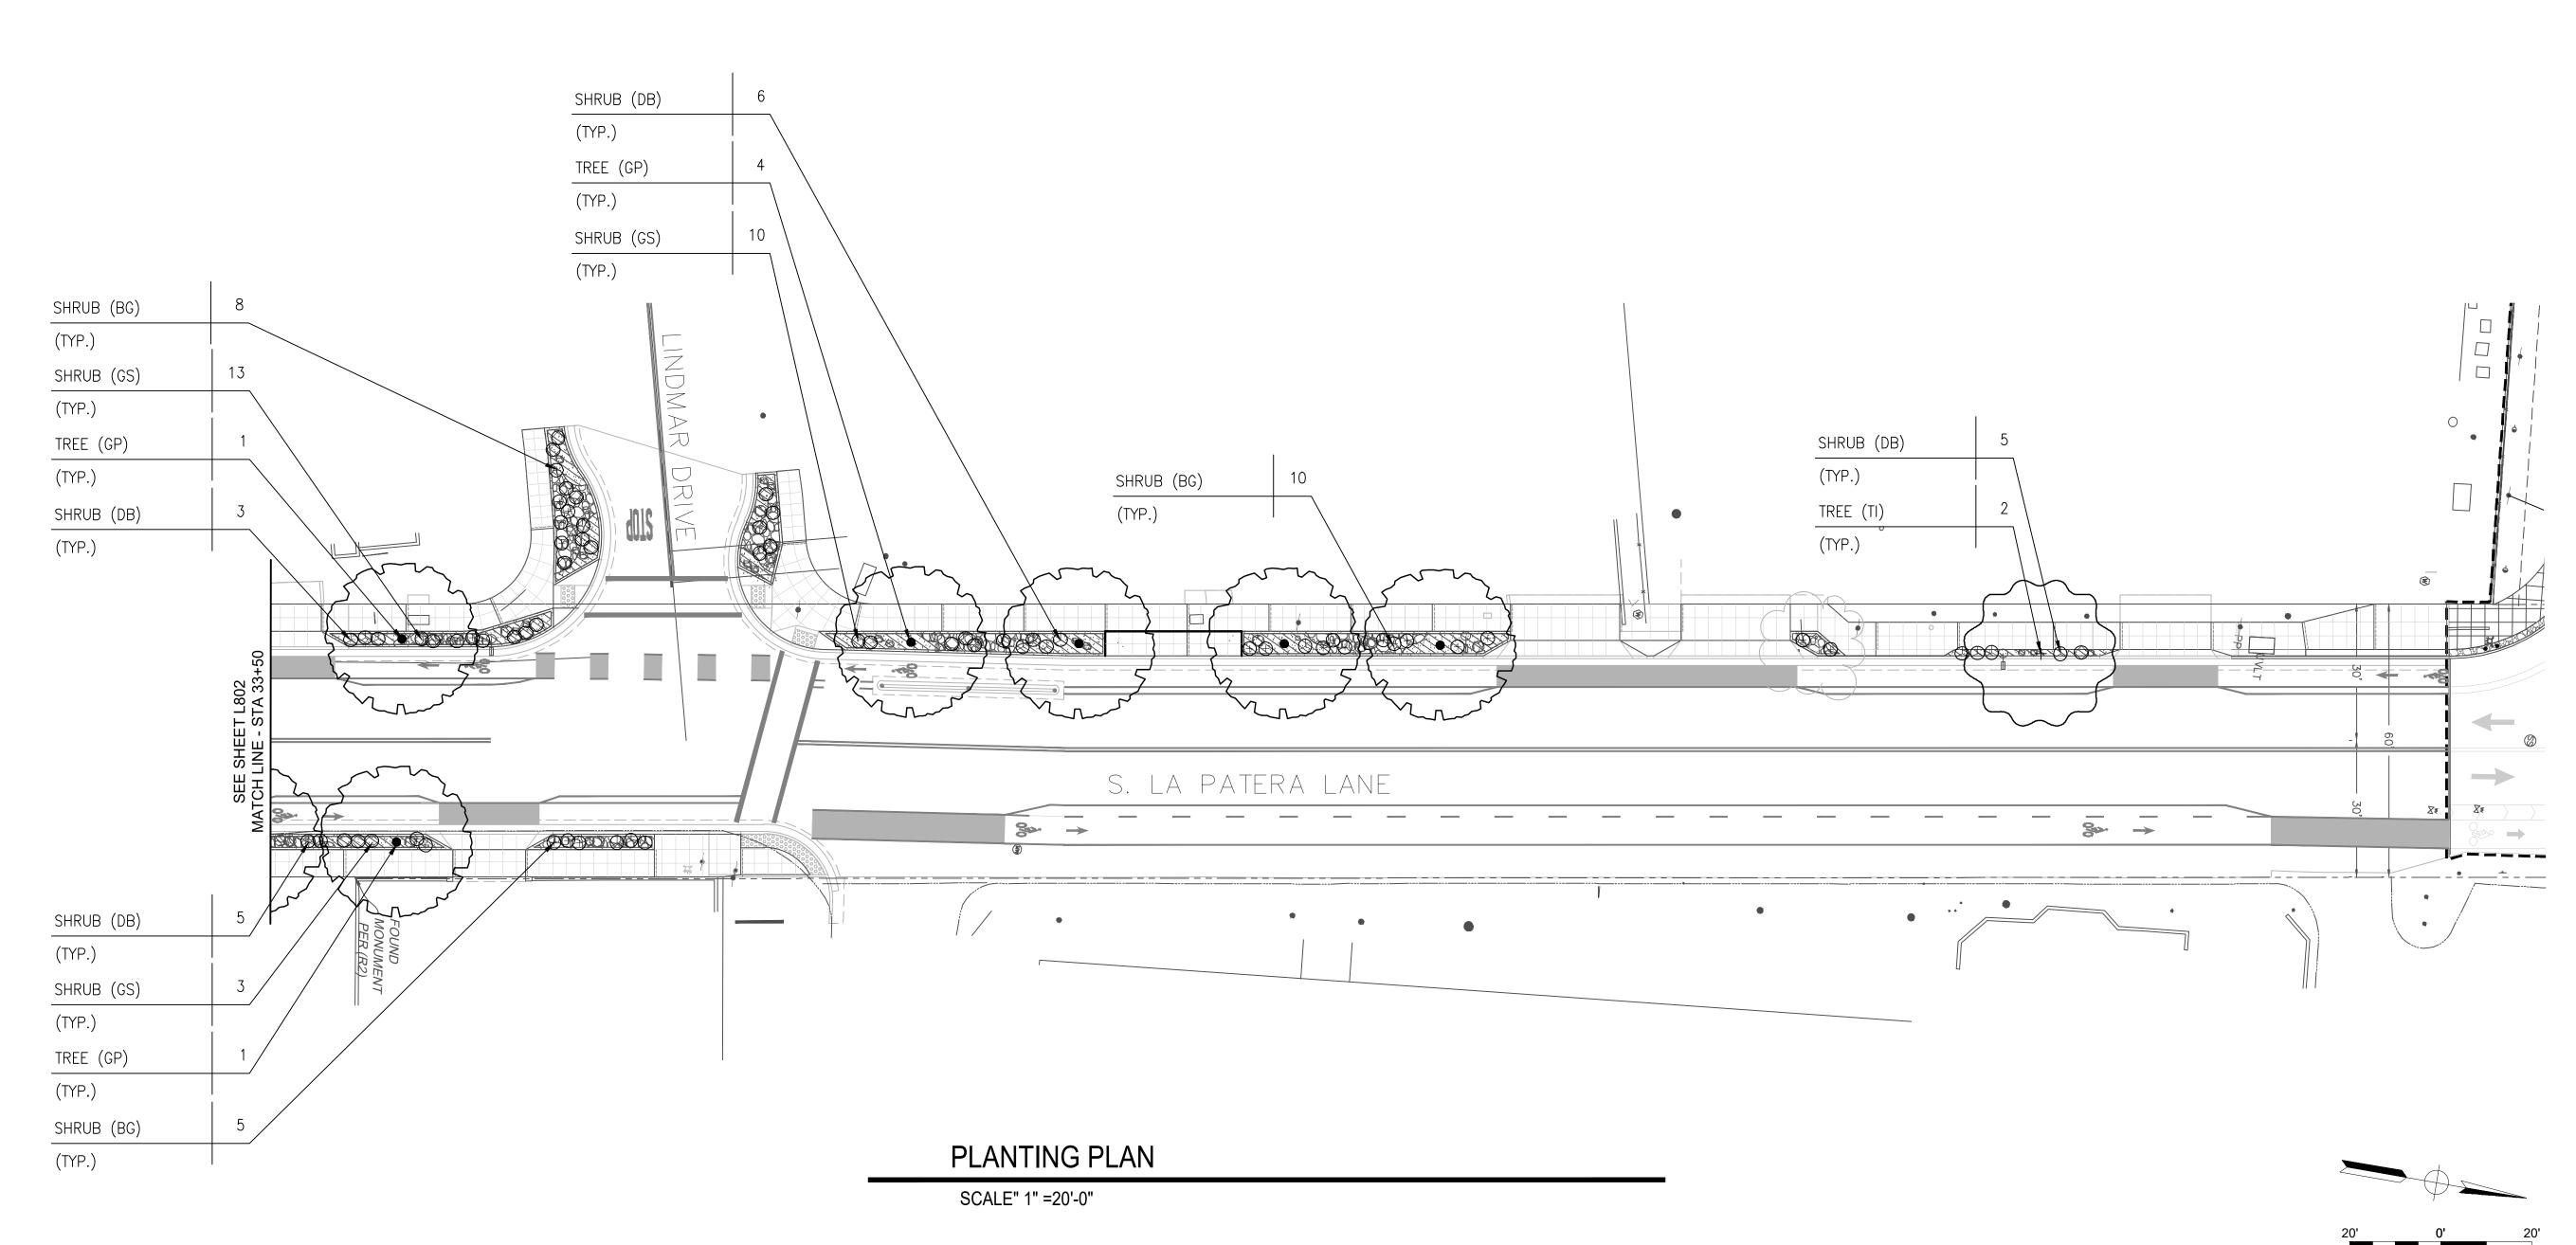

PLANT LEGEND - See Sheet L800

SYMBOLS **BOTANIC NAME** Geijera parviflora

Tabebuia impetiginosa Existing Tree (Protect in Place)

⊕ BG Bouteloua gracilis — Blonde Ambition

○ DB Dudleya brittonii


O GS Grindelia stricta — Venulosa


REFER TO SHEET L-800 FOR PLANTING LEGEND. REFER TO SHEETS L-1001 FOR TYPICAL PLANTING DETAILS & NOTES

PROJECT ENGINEER: R.C.E. EXP.

HORIZ: 1"=20' VERT: 1"=4'

NOTES:

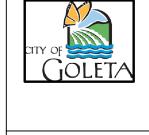

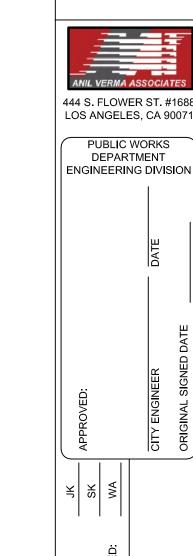


444 S. FLOWER ST. #1688 PUBLIC WORKS
DEPARTMENT
ENGINEERING DIVISION

: IMPROVEMENT TRAIN DEPOT)

SOUTH I PROJE


CIP-9079 BID NO. SHT. DES

SHEET 36 OF 40

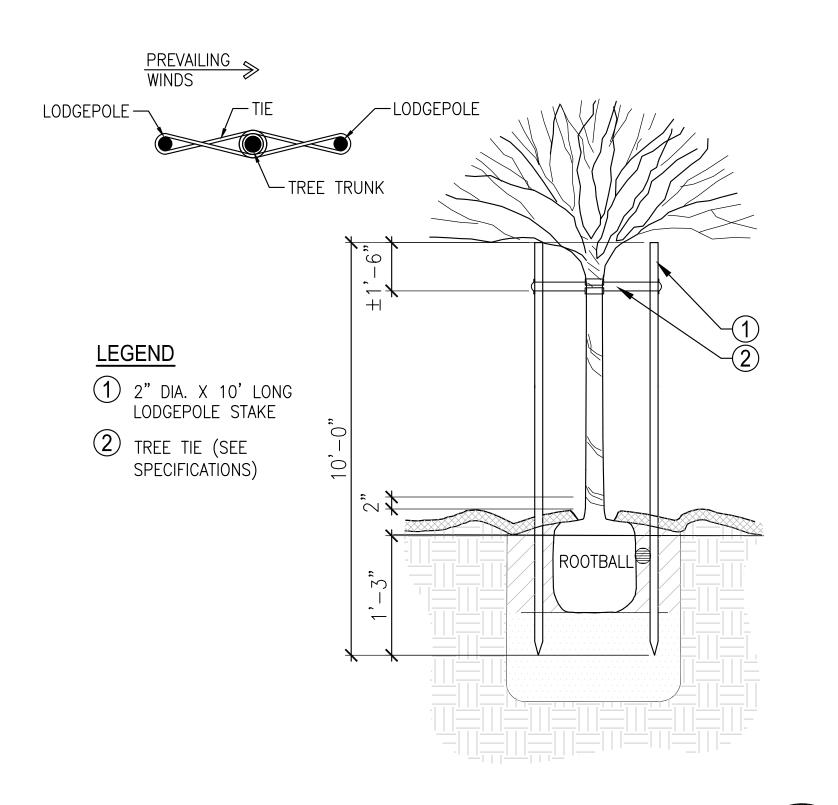

DOUBLE TREE STAKING

Scale: NTS

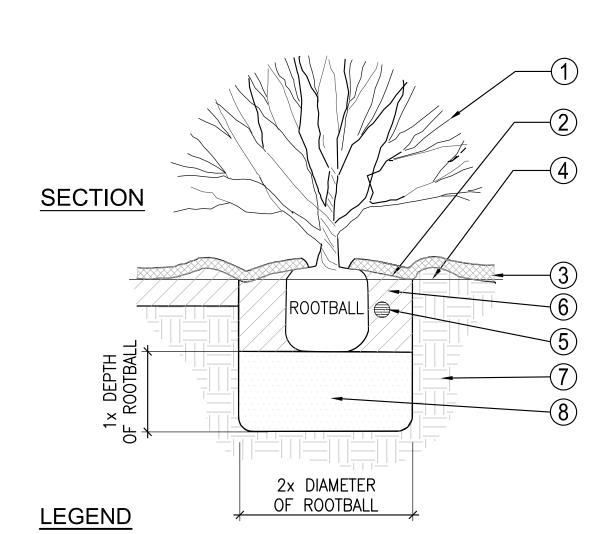

(5) FERTILIZER TABLETS

(7) UNDISTURBED SOIL

AND HAND TAMP.

(6) AMENDED BACKFILL SOIL

8 EXCAVATE SOIL, REPLACE

- (1) CONTAINER PLANT
- 2 WATER BASIN, 2" MIN. DEPTH ABOVE ADJACENT GRADE
- 3 3" MULCH LAYER. KEEP 2"MIN. CLEAR FROM CROWN
- 4) FINISH GRADE

NOTE:

SET TOP OF ROOTBALL 1" ABOVE SURROUNDING GRADE.

SHRUB PLANTING

Scale: 1" = 1'-0"

- 1 TREE 2 SET TOP OF ROOTBALL ABOVE SURROUNDING GRADE. (1" ABOVE FOR 5-15 GAL., 2" ABOVE FOR 24" BOX, 3" ABOVE FOR 36" BOX AND LARGER)
- 3 WATER BASIN: 4" MIN. DEPTH ABOVE ADJACENT GRADE
- (4) FINISH GRADE

LEGEND

- (5) 3" MULCH LAYER
- (6) AMENDED BACKFILL
- (7) PLANT TABLETS
- (8) UNDISTURBED SOIL
- 9 EXCAVATE SOIL, REPLACE AND HAND TAMP
- (10) KEEP MULCH 3"MIN. CLEAR FROM CROWN

TREE PLANTING

Scale: 1" = 1'-0"

- PLANTING AREA <u>PLAN</u> **SECTION**

LEGEND

- 2 24" DEEP ROOT BARRIER, EXTENDS 6' ON EITHER SIDE OF TREE ALONG CURB OR EDGE OF PAVING
- 3 BACK OF CURB OR EDGE OF PAVING, TYPICAL. SEE PLANS.
- 4 TREE ROOTBALL SIZE VARIES
- TREE TRUNK. REFER TO PLAN/ LEGEND FOR 6 TOP EDGE OF ROOT CONTROL BARRIER 1" BELOW TOP OF CURB OR PAVING

2x DIAMETER OF ROOTBALL

planting_tree

- (7) FINISH GRADING / FINISH SURFACE
- 8 MULCH 9 PLANTING SOIL
- NOTE:
- 5 4" WIDE MIN. X 24" DEEP TRENCH ALONG CURB OR PAVING. BACKFILL AGAINST BARRIER WITH EXCAVATED SOIL FROM TRENCH
- 1. TREES WITHIN FIVE (5) FEET OF ANY HARDSCAPE, PAVEMENT, OR CURB SHALL HAVE ROOT BARRIERS
 - ("BIOBARRIER"). ROOT BARRIERS SHALL NOT BE WRAPPED AROUND THE ROOTBALL 2. REFER TO ROOT BARRIER MANUFACTURER DETAILS, NOTES

AND SPECS FOR ADDITIONAL INSTALLATION REQUIREMENTS TYPICAL ROOT BARRIER CONDITION

PROJECT ENGINEER: R.C.E. EXP.

Scale:

03-04-24

DATE

- 1. ALL ELECTRICAL WORK SHALL BE DONE IN CONFORMANCE WITH THE CITY OF GOLETA STANDARDS. THE 2018 CALTRANS STANDARD SPECIFICATIONS AND THE STANDARD PLANS. THE LATEST VERSION OF 2014 CA MUTCD, AND IN ACCORDANCE WITH THE PROJECT SPECIAL PROVISIONS.
- 2. THE CONTRACTOR SHALL BE RESPONSIBLE FOR REPORTING ALL CONFLICTS, ERRORS, OMISSIONS, ETC TO THE ENGINEER IMMEDIATELY UPON DISCOVERY IF SO DIRECTED BY THE ENGINEER, THE CONTRACTOR SHALL STOP WORK UNTIL REMEDIAL ACTION CAN BE TAKEN. ANY COST RESULTING FROM THE CONTRACTOR'S FAILURE TO REPORT OR FAILURE TO STOP WORK AS DIRECTED WILL BE THE RESPONSIBILITY OF THE CONTRACTOR.
- 3. THE CONTRACTOR IS HEREBY NOTIFIED THAT PRIOR TO COMMENCING CONSTRUCTION, THE CONTRACTOR IS RESPONSIBLE FOR CONTACTING ALL UTILITY COMPANIES FOR VERIFICATION AT THE CONSTRUCTION SITE OF THE LOCATIONS OF ALL OVERHEAD AND UNDERGROUND FACILITIES WHERE SUCH FACILITIES MAY CONFLICT WITH PLACEMENT OF IMPROVEMENTS SHOWN ON THIS PLAN. CALL "DIG ALERT" AT 811, 2 WORKING DAYS PRIOR TO ANY EXCAVATIONS.
- 4. THE CONTRACTOR SHALL LOCATE ALL EXISTING UTILITIES PRIOR TO EXCAVATIONS FOR FOUNDATIONS.
- 5. THE LOCATIONS OF ALL BOXES, CONDUITS AND OTHER EQUIPMENT SHOWN ON THIS PLAN ARE APPROXIMATE AND MAYBE CHANGED TO SUIT FIELD CONDITIONS AS DIRECTED BY THE ENGINEER.
- 6. ALL PULL BOXES SHALL BE No, 5 UNLESS OTHERWISE NOTED.

SYMBOLS:

•**1** POLE MOUNTED SINGLE LIGHT FIXTURE (1)NUMBER INDICATE CIRCUIT NUMBER


PB UNDERGROUND PULL BOX

---- UNDERGROUND CONDUIT & WIRES

KEY NOTE:


1"C - 2#6 + 1#12 GND


LIGHTING FIXTURE SCHEDULE						
TYPE	DESCRIPTION	VOLT	MANUFACTURER & CATALOG #	LAMP		
A 35	SINGLE POLE MOUNTED LIGHT FIXTURE, MOUNTING HEIGHT=15'-0", 3000K COLOR TEMPERATURE, HOUSE SIDE SHIELD LUMINAIRE, TEXTURED GREEN FINISH.	120V	LUMEX #DMS50W32LED3K-G3-LE2F-120-DMG-HS-GNTX. THE POLE NUMBER SHALL BE RTA90-BA, MOUNTING LM-1A-GNTX, TEXTURED GREEN FINISH OR APPROVED EQUAL	LED 35W		

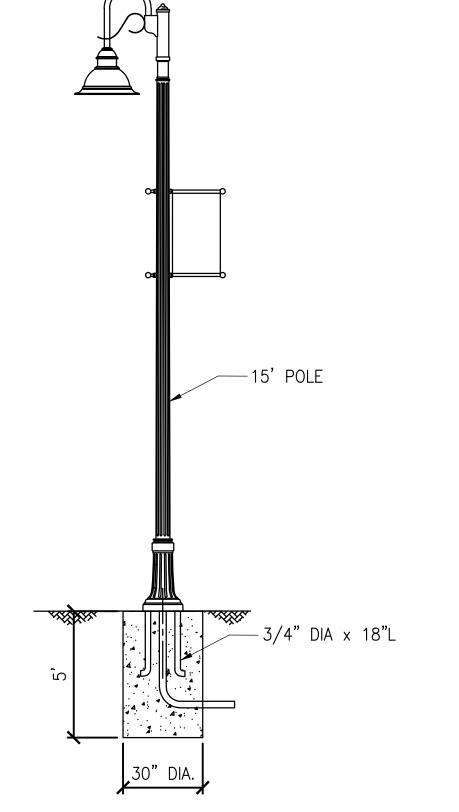


LIGHTING POLE DETAIL SCALE: NTS



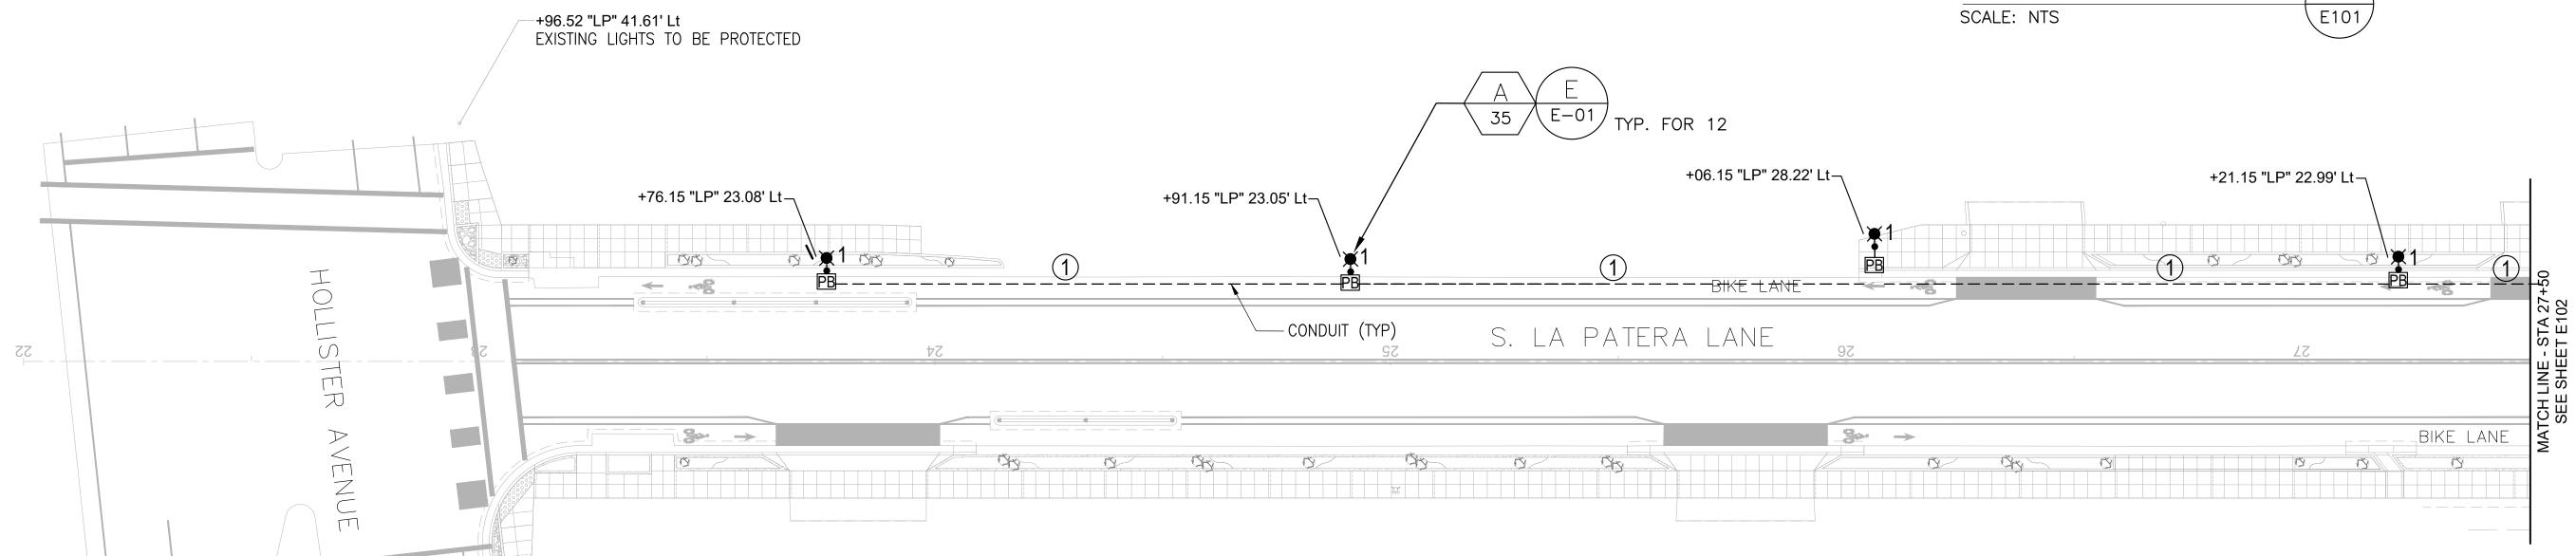

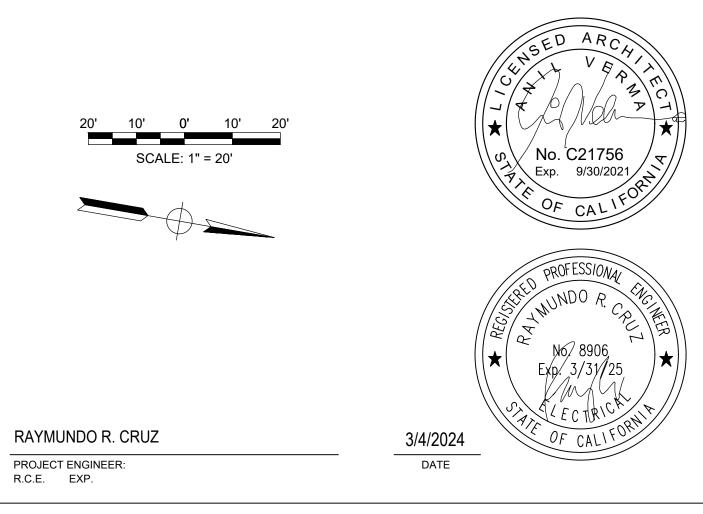

CITY OF SOLETA

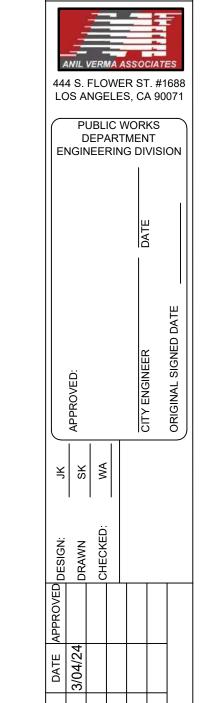

OLETA TRAIN DEPOT)

N - LA PATERA LANE
INIVITATIONI EOD DIP


SOUTH LA PATERA LANE IN PROJECT (FOR GOLETA T LIGHTING PLAN - LA PAT

CIP-9079
PBW NO.

BID NO. SHT. DES

E101
DWG NO.

SHEET 37 OF 40

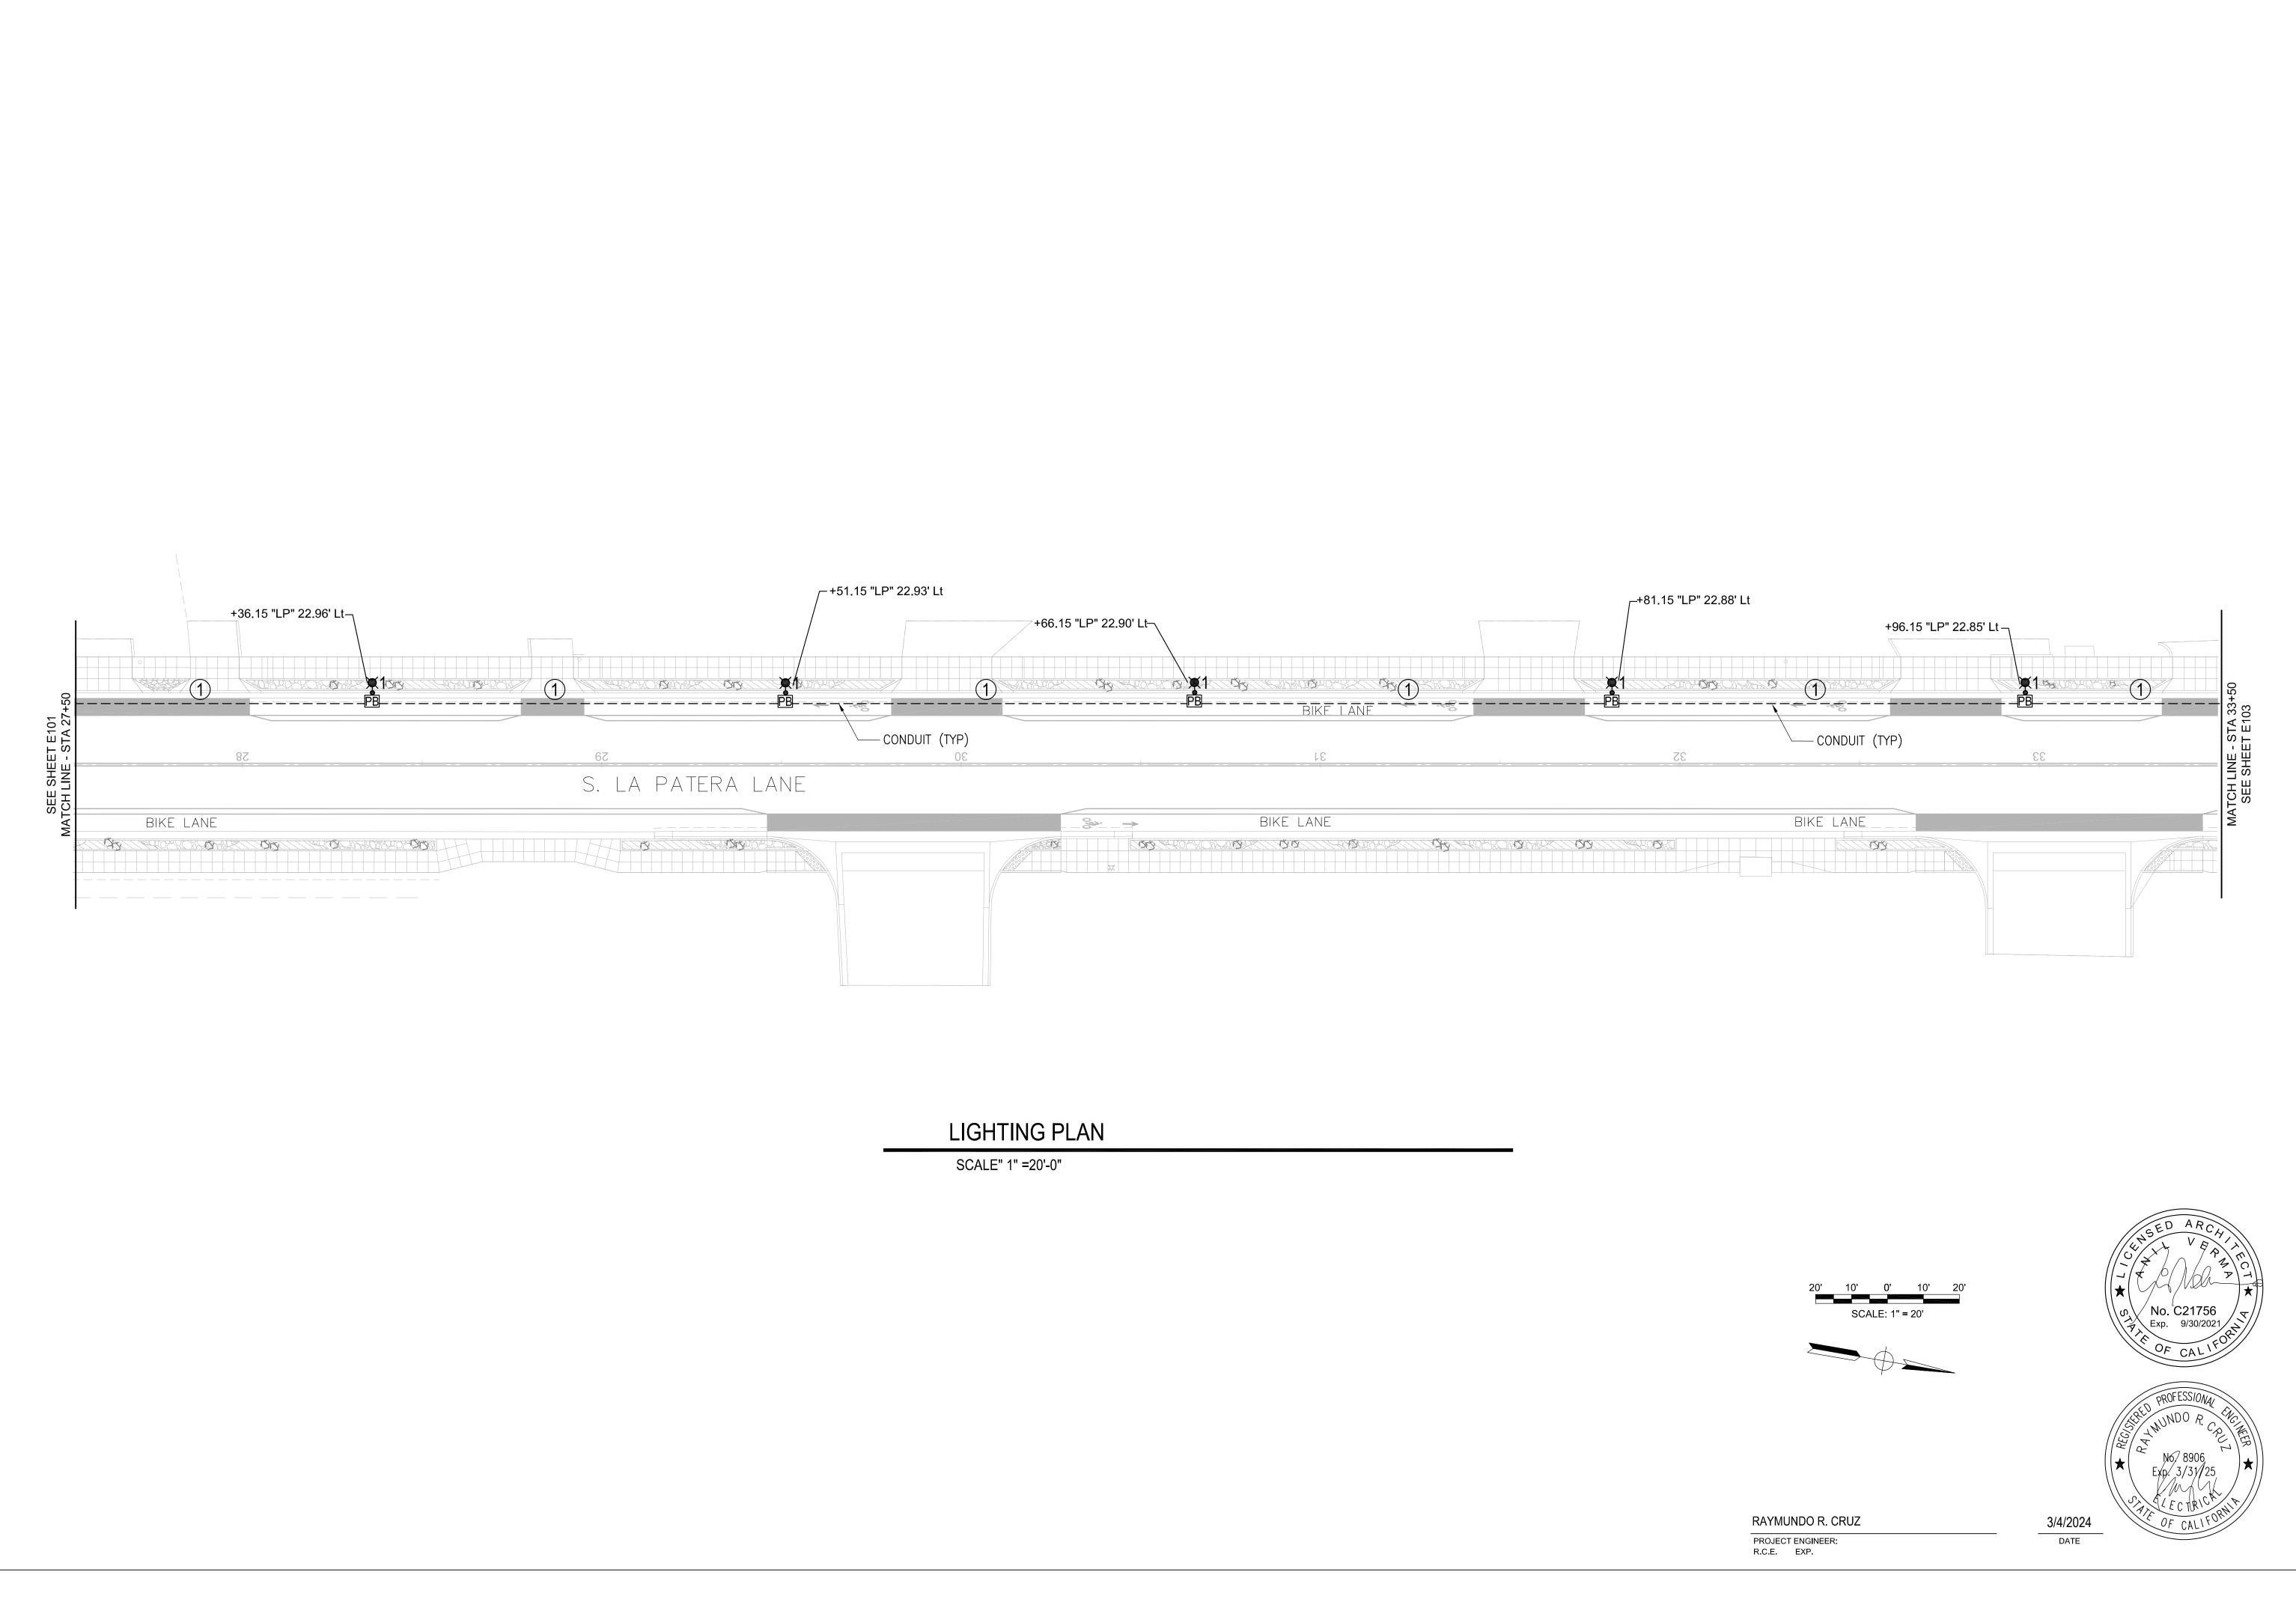



SOUTH LA PROJECT LIGHT


CIP-9079 BID NO. SHT. DES. E102 DWG NO.

SHEET 38 OF 40



— 120/240V METERED SERVICE PEDESTAL. SEE

SCALE" 1" =20'-0"

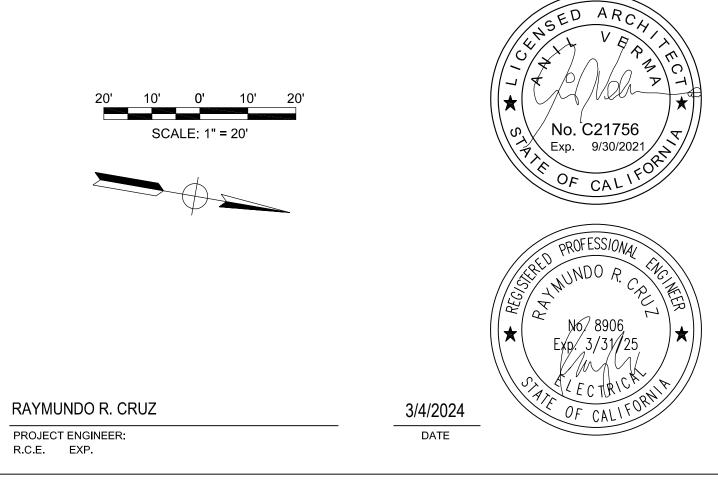

OVEMENT DEPOT) LANE


444 S. FLOWER ST. #1688 LOS ANGELES, CA 90071


PUBLIC WORKS
DEPARTMENT
ENGINEERING DIVISION

SOUTH LA PROJECT LIGHT

CIP-9079 BID NO. SHT. DES. E103 DWG NO.

SHEET 39 OF 40

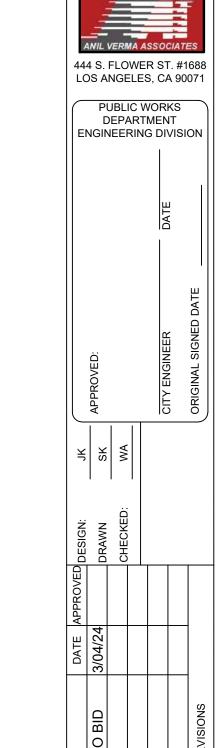

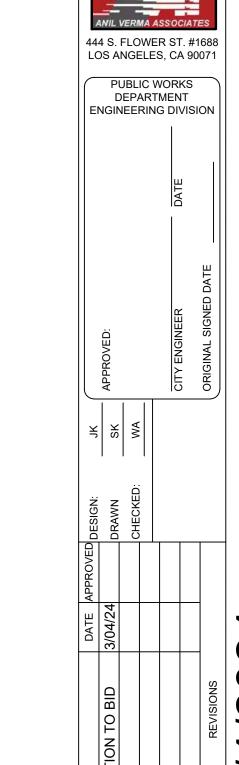


CIP-9079 BID NO. SHT. DES E104 SHEET 40 OF 40


CONCRETE PAD FRONT VIEW RIGHT SIDE



ENCLOSURE CONSTRUCTION NOTES:

- 1. EXTERIOR 1/8" ALUMINUM, AND INTERIOR 14 GA COLD ROLLED STEEL ELECTRICALLY WELDED AND REINFORCED WHERE REQUIRED.
- 2. CONSTRUCTION WILL BE NEMA 3R, RAINTIGHT.
- 3. ALL NUTS, BOLTS AND SCREWS WILL BE STAINLESS STEEL.
- 4. NUTS, BOLTS & SCREWS WILL BE STAINLESS STEEL.
- 5. NAMEPLATES WILL BE PROVIDED AS REQUIRED.
- 6. CONTROL WIRING WILL BE MARKED AT BOTH ENDS BY PERMANENT WIRE MARKERS.
- 7. A PLASTIC COVERED WIRING DIAGRAM WILL BE ATTACHED TO THE INSIDE OF THE FRONT DOOR.
- 8. ENCLOSURE WILL BE FACTORY WIRED AND CONFORM TO REQUIRED NEMA AND UL 508A STANDARDS.
- 9. ANODIZE AFTER FABRICATION.

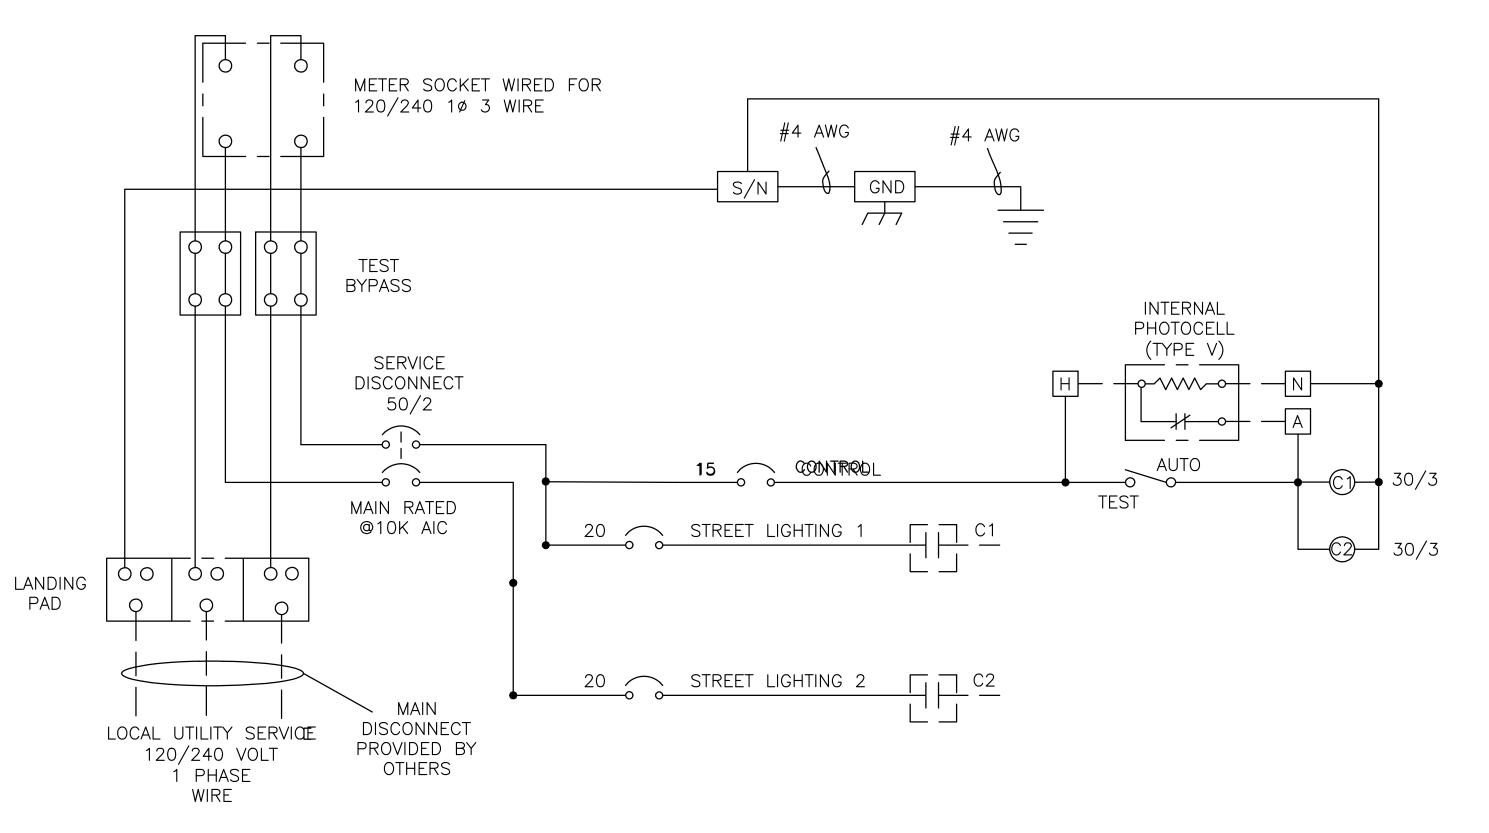

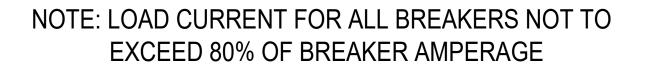



RAYMUNDO R. CRUZ

PROJECT ENGINEER: R.C.E. EXP.

